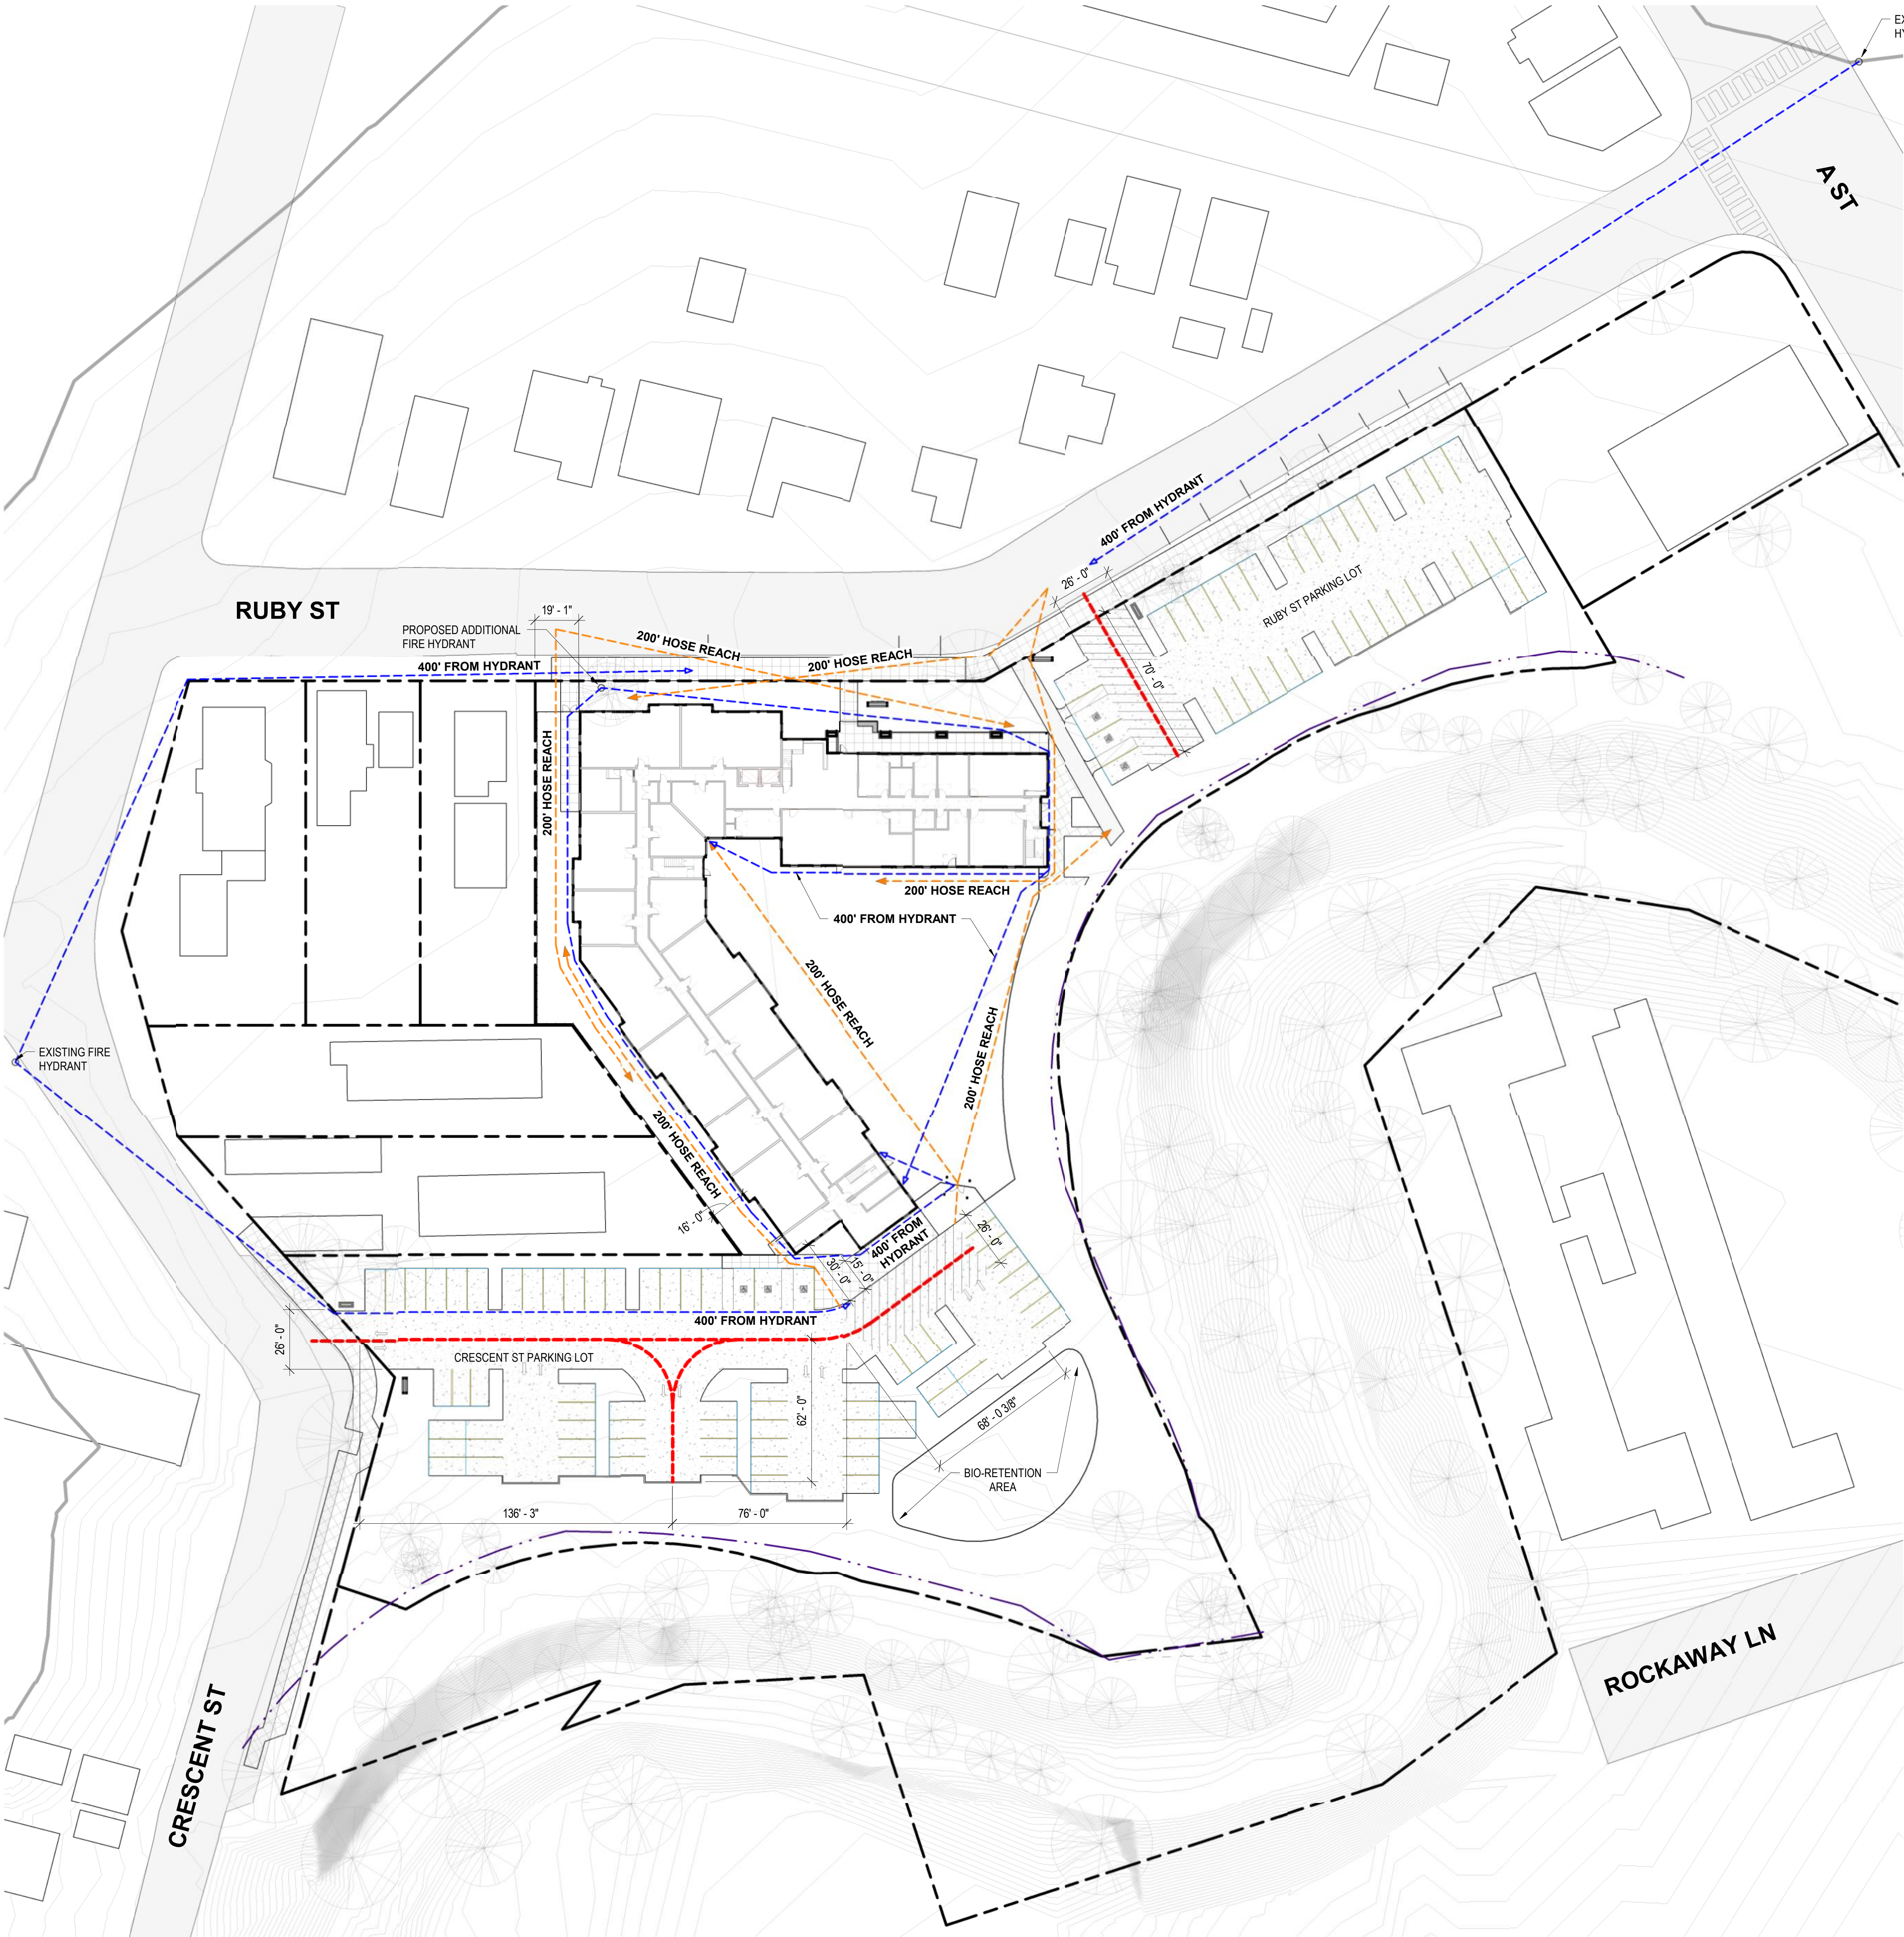


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ABBREVIATIONS

AB	ANCHOR BOLT	JAN	JANITOR
ABV	ABOVE	JT	JOINT
AC	AIR CONDITIONING	KD	KILN DRIED
ACC	ASPHALTIC CONCRETE	KIT	KITCHEN
ACC	ACCESSIBLE	KPL	KICK PLATE
A.C.P.	ACOUSTIC CEILING PANEL	L	ANGLE
A.C.T.	ACOUSTIC CEILING TILE	LAU	LAUNDRY
A.D.	AREA DRAIN	LAV	LAVATORY
ADDL	ADDITIONAL	LIN	LINOLEUM
ADOM	ADJENDUM	LVT	LUXURY VINYL TILE
ADH	ADHESIVE	LVL	LEVEL
ADJ	ADJACENT OR ADJUSTABLE	MAX	MAXIMUM
AFF	ABOVE FINISHED FLOOR	MB	MACHINE BOLT
ALUM	ALUMINUM	MC	MEDICINE CABINET
ALT	ALTERNATIVE	MECH	MECHANICAL
AMT	AMOUNT	MTL	METAL
ANOD	ANODIZED	MFR	MANUFACTURER
AP	ACCESS PANEL	MH	MINIMUM
APL	ASSUMED PROPERTY LINE	MTD	MOUNTED
APPROX	APPROXIMATE	N/A	NOT APPLICABLE
ARCH	ARCHITECT(URAL)	NIC	NOT IN CONTRACT
ASSY	ASSEMBLY	NTS	NOT TO SCALE
AV	AUDIO VISUAL	OI	OVER
AUTO	AUTOMATIC	OC	ON CENTER
BALC	BALCONY	OD	OUTSIDE DIAMETER
BATT	BATTING	OFC	OFFICE
BD	BOARD	OFD	OVERFLOW DRAIN
BLDG	BUILDING	OH	OVERHEAD
BLKG	BLOCKING	OITC	OUTSIDE-INSIDE TRANSMISSION CLASS
BM	BEAM	OPP	OPPOSITE
B.O.C.	BOTTOM OF CURB	OPP HD/OPH	OPPOSITE HAND
B.O.D.	BASIS OF DESIGN	OPNG	OPENING
BOT	BOTTOM	PCG	PRECAST CONCRETE
B.O.W.	BACK OF SIDEWALK	PERF	PERFORATED
BRKT	BRACKET	PL	PLATE
BTW, B/W	BETWEEN	P.L.	PROPERTY LINE
BUR	BUILT UP ROOFING	PLAM	PLASTIC LAMINATE
CAB	CABINET	PR	PAIR
CEM	CEMENT	PT	PRESSURE TREATED OR POST TENSIONED
CEM PLAS	CEMENT PLASTER	PTD	PLYWOOD
CIP	CAST IN PLACE	PLYWD, PLY	PLYWOOD
CJ	CONTROL JOINT	PREFAB	PREFABRICATED
CL	CENTERLINE	PV	PHOTOVOLTAIC
CL	CLOSE	PVC	POLYVINYL CHLORIDE (RIGID)
CLG	CEILING	QTY	QUANTITY
CLKG	CAULKING	R	RISER
CLR	CLEAR	RCP	REFLECTED CEILING PLAN
CMU	CONCRETE MASONRY UNIT	REF	REFERENCE OR REFRIGERATOR
COL	COLUMN	REINF	REINFORCE(D) (ING) (MENT)
CONC	CONCRETE	REQ	REQUIRED
CONN	CONNECTION	RESUL	RESILIENT
CONT	CONTINUOUS	RFG	ROOFING
CONST	CONSTRUCTION	RM	ROOM
CONTR	CONTRACTOR	RO	ROUGH OPENING
CSMT	CASEMENT	RWL	RAINWATER LEADER
CT	CERAMIC TILE	SAF	SELF-ADHERED FLASHING
CTSK	COUNTERSINK	SC	SOLID CORE
D	DRYER	S.C.D.	SEE CIVIL DRAWINGS OR SEE CONCRETE DRAWINGS
DBL	DOUBLE	SD	SHV
DEMO	DEMOLISH OR DEMOLITION	SHV	SQUARE INCH
DF	DOUGLAS FIR	SO IN	SO IN
DIA	DIAMETER	S.S.D.	SEE STRUCTURAL DRAWINGS
DIM	DIMENSION	SECT	SECTION
DN	DOWN	S.E.D.	SEE ELECTRICAL DRAWINGS
DS	DOWNSPOUT	S.F.	SQUARE FOOT OR SUBFLOOR
DTL	DETAIL	SG	SAFETY GLAZING
DW	DISHWASHER	SM	SIMILAR
DWG	DRAWING	S.M.D.	SEE MECHANICAL DRAWINGS
(E)	EXISTING	SP	STANDPIPE
EA	EACH	S.P.D.	SEE PLUMBING DRAWINGS
EB	EXPANSION BOLT	SPECS	SPECIFICATIONS
EJ	EXPANSION JOINT	SQ	SQUARE
ELEV	ELEVATION OR ELEVATOR	SSTL, SS	SANITARY SEWER
ELEC	ELECTRIC	STC	STAINLESS STEEL
ENCL	ENCLOSURE ENCLOSED	STD	SOUND TRANSMISSION CLASS STANDARD
EP	ELECTRIC PANEL	STL	STEEL
EQ	EQUAL	STOR	STORAGE
EQPT	EQUIPMENT	STRUCT, STRL	STRUCTURAL
EXP	EXPANSION	SUSP	SUSPENDED
EXT	EXTERIOR	SUSP CLG	SUSPENDED CEILING
FACP	FIRE ALARM CONTROL PANEL	SV	SHEET VINYL
FAU	FORCED AIR UNIT	SYS	SYSTEM
FCB	FIBER CEMENT BOARD	T&G	TONGUE AND GROOVE
FCP	FIBER CEMENT PANEL	TDS	TIE DOWN SYSTEM
FD	FLOOR DRAIN OR FIRE DEPARTMENT	TEL	TELEPHONE
FDN	FOUNDATION	TEMP	TEMPERATURE OR TEMPORARY
FE	FIRE EXTINGUISHER	TEMP GL	TEMPERED GLASS
FEC	FIRE EXTINGUISHER CABINET	THK	THICKNESS
FF	FINISHED FLOOR	T.O.	TOP OF
FIN	FINISH OR FINISHED	T.O.C.	TOP OF CONCRETE
FLEX	FLEXIBLE	T.O.PL	TOP OF PLATE
FLR	FLOOR	T.O.S.	TOP OF SLAB
F.O.B.	FACE OF BEAM	T.O.SF	TOP OF SUBFLOOR
F.O.C.	FACE OF CONCRETE	T.O.W	TOP OF WALL
F.O.F.	FACE OF FINISH	TPD	TOILET PAPER DISPENSER
F.O.S.	FACE OF STUD	T	TREAD OR TEMPERED
F.O.W.	FACE OF WALL	TYP	TYPICAL
FR	FIRE RESISTANCE	UL	UNDERWRITERS LABORATORY
FRTW	FIRE RETARDANT TREATED WOOD	UJN	UNLESS OTHERWISE NOTED
FRP	FIBER REINFORCED PLASTIC	VCT	VINYL COMPOSITION TILE
FT	FOOT	VERT	VERTICAL
FTG	FOOTING	VEST	VESTIBULE
GA	GAUGE	VGF	VERTICAL GRAIN DOUGLAS FIR
GALV	GALVANIZED	VIF	VERIFY IN FIELD
GAR	GARAGE	W	WASHER
GFCI	GROUND FAULT CIRCUIT INTERRUPTER	W	WITH
GLAZ	GLAZING	WC	WATER CLOSET
GSM	GALVANIZED SHEET METAL	WD	STACKED WASHER AND DRYER
GWB	GYPSSUM WALL BOARD	WD	WOOD
GYP	GYPSSUM	WDW	WINDOW
HB	HOSE BIB	WH	WATER HEATER
HC	HOLLOW CORE	WID	WITHOUT
HD	HOLD-DOWN	W.O.	WHERE OCCURS
HM	HOLLOW METAL	WP	WATERPROOF
HORIZ	HORIZONTAL	WRB	WEATHER RESISTIVE BARRIER
HPLAM	HIGH PRESSURE LAMINATE	WS	WHEELSTOP
HR	HOUR OR HANDRAIL	WSC	WAINSCOT
HSS	TUBE STEEL	WWF	WELDED WIRE FABRIC
HT	HEIGHT		
HVAC	HEATING, VENTILATION, AIR-CONDITIONING		
HYD	HYDRANT		
IIC	IMPACT INSULATION CLASS		
IN	INCHES		
INSUL	INSULATION		
INT	INTERIOR		

SITE PLAN KEY	
---	PROPERTY LINE
- - -	FEMA FLOODPLAIN
- - -	CREEK SETBACK
---	200' HOSE LENGTH FROM TRUCK
---	400' HOSE LENGTH FROM HYDRANT
---	FIRE TRUCK ACCESS

Fire Access Diagram 1
1" = 30'-0"

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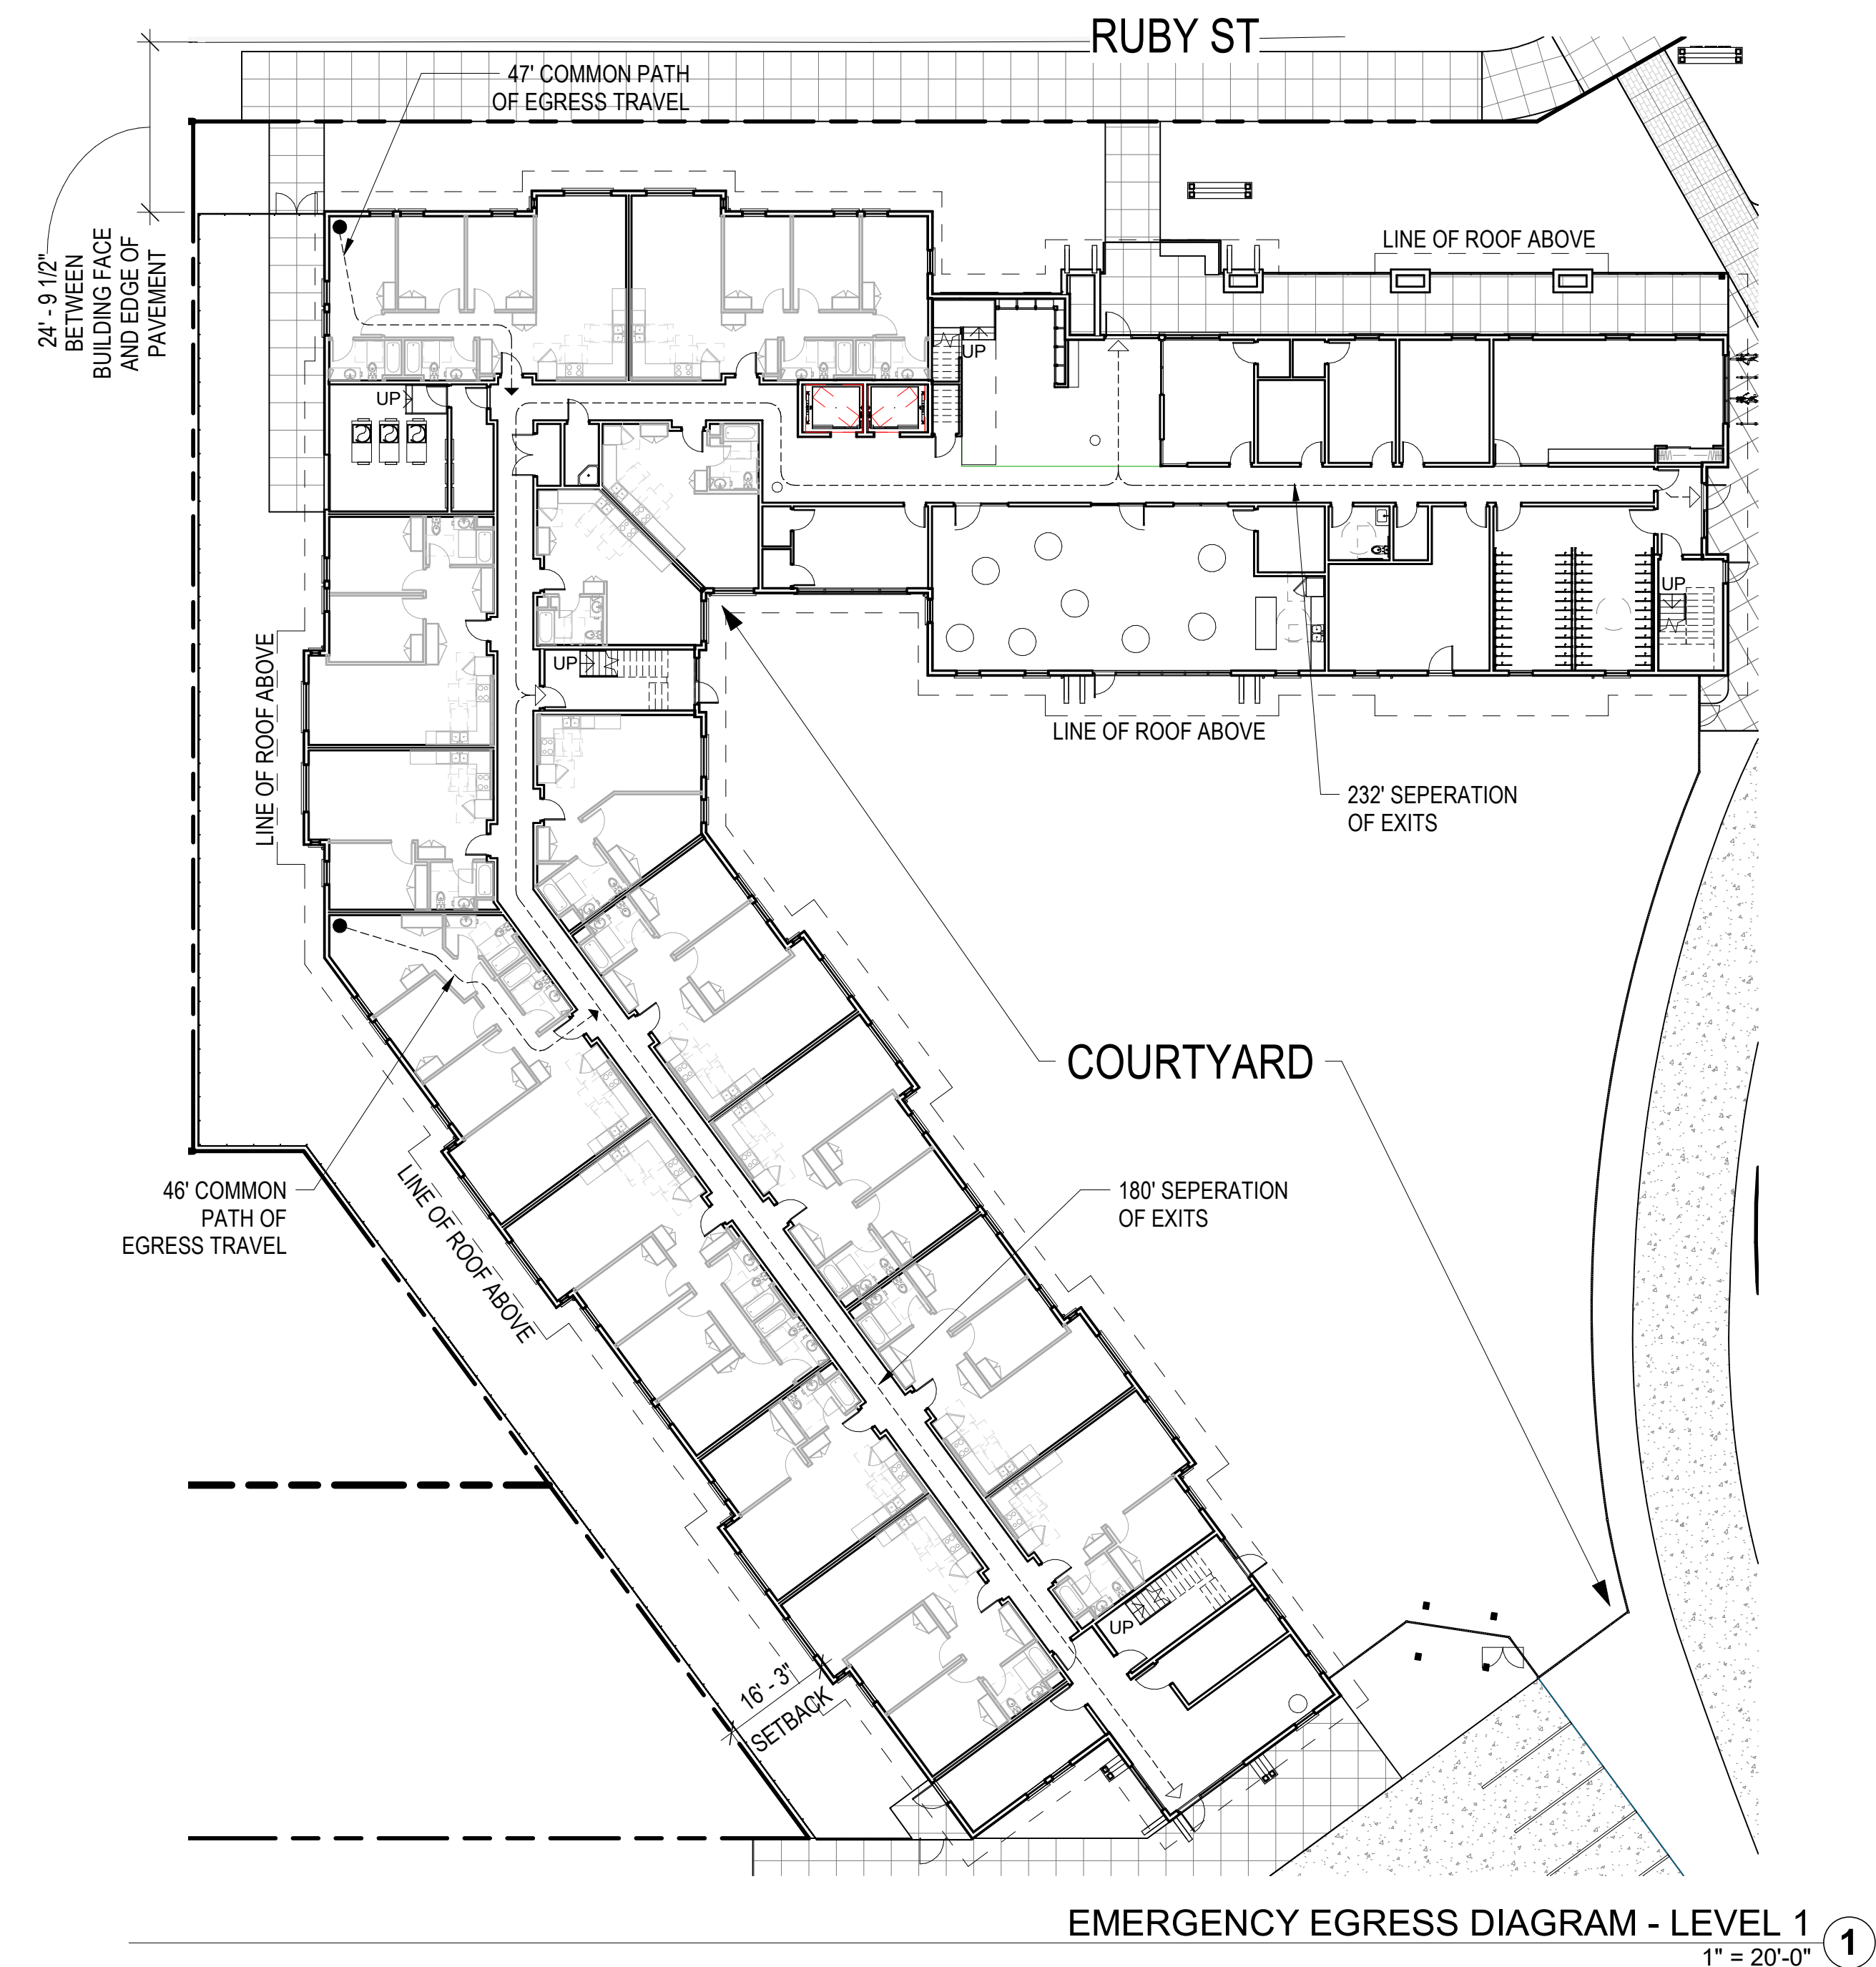
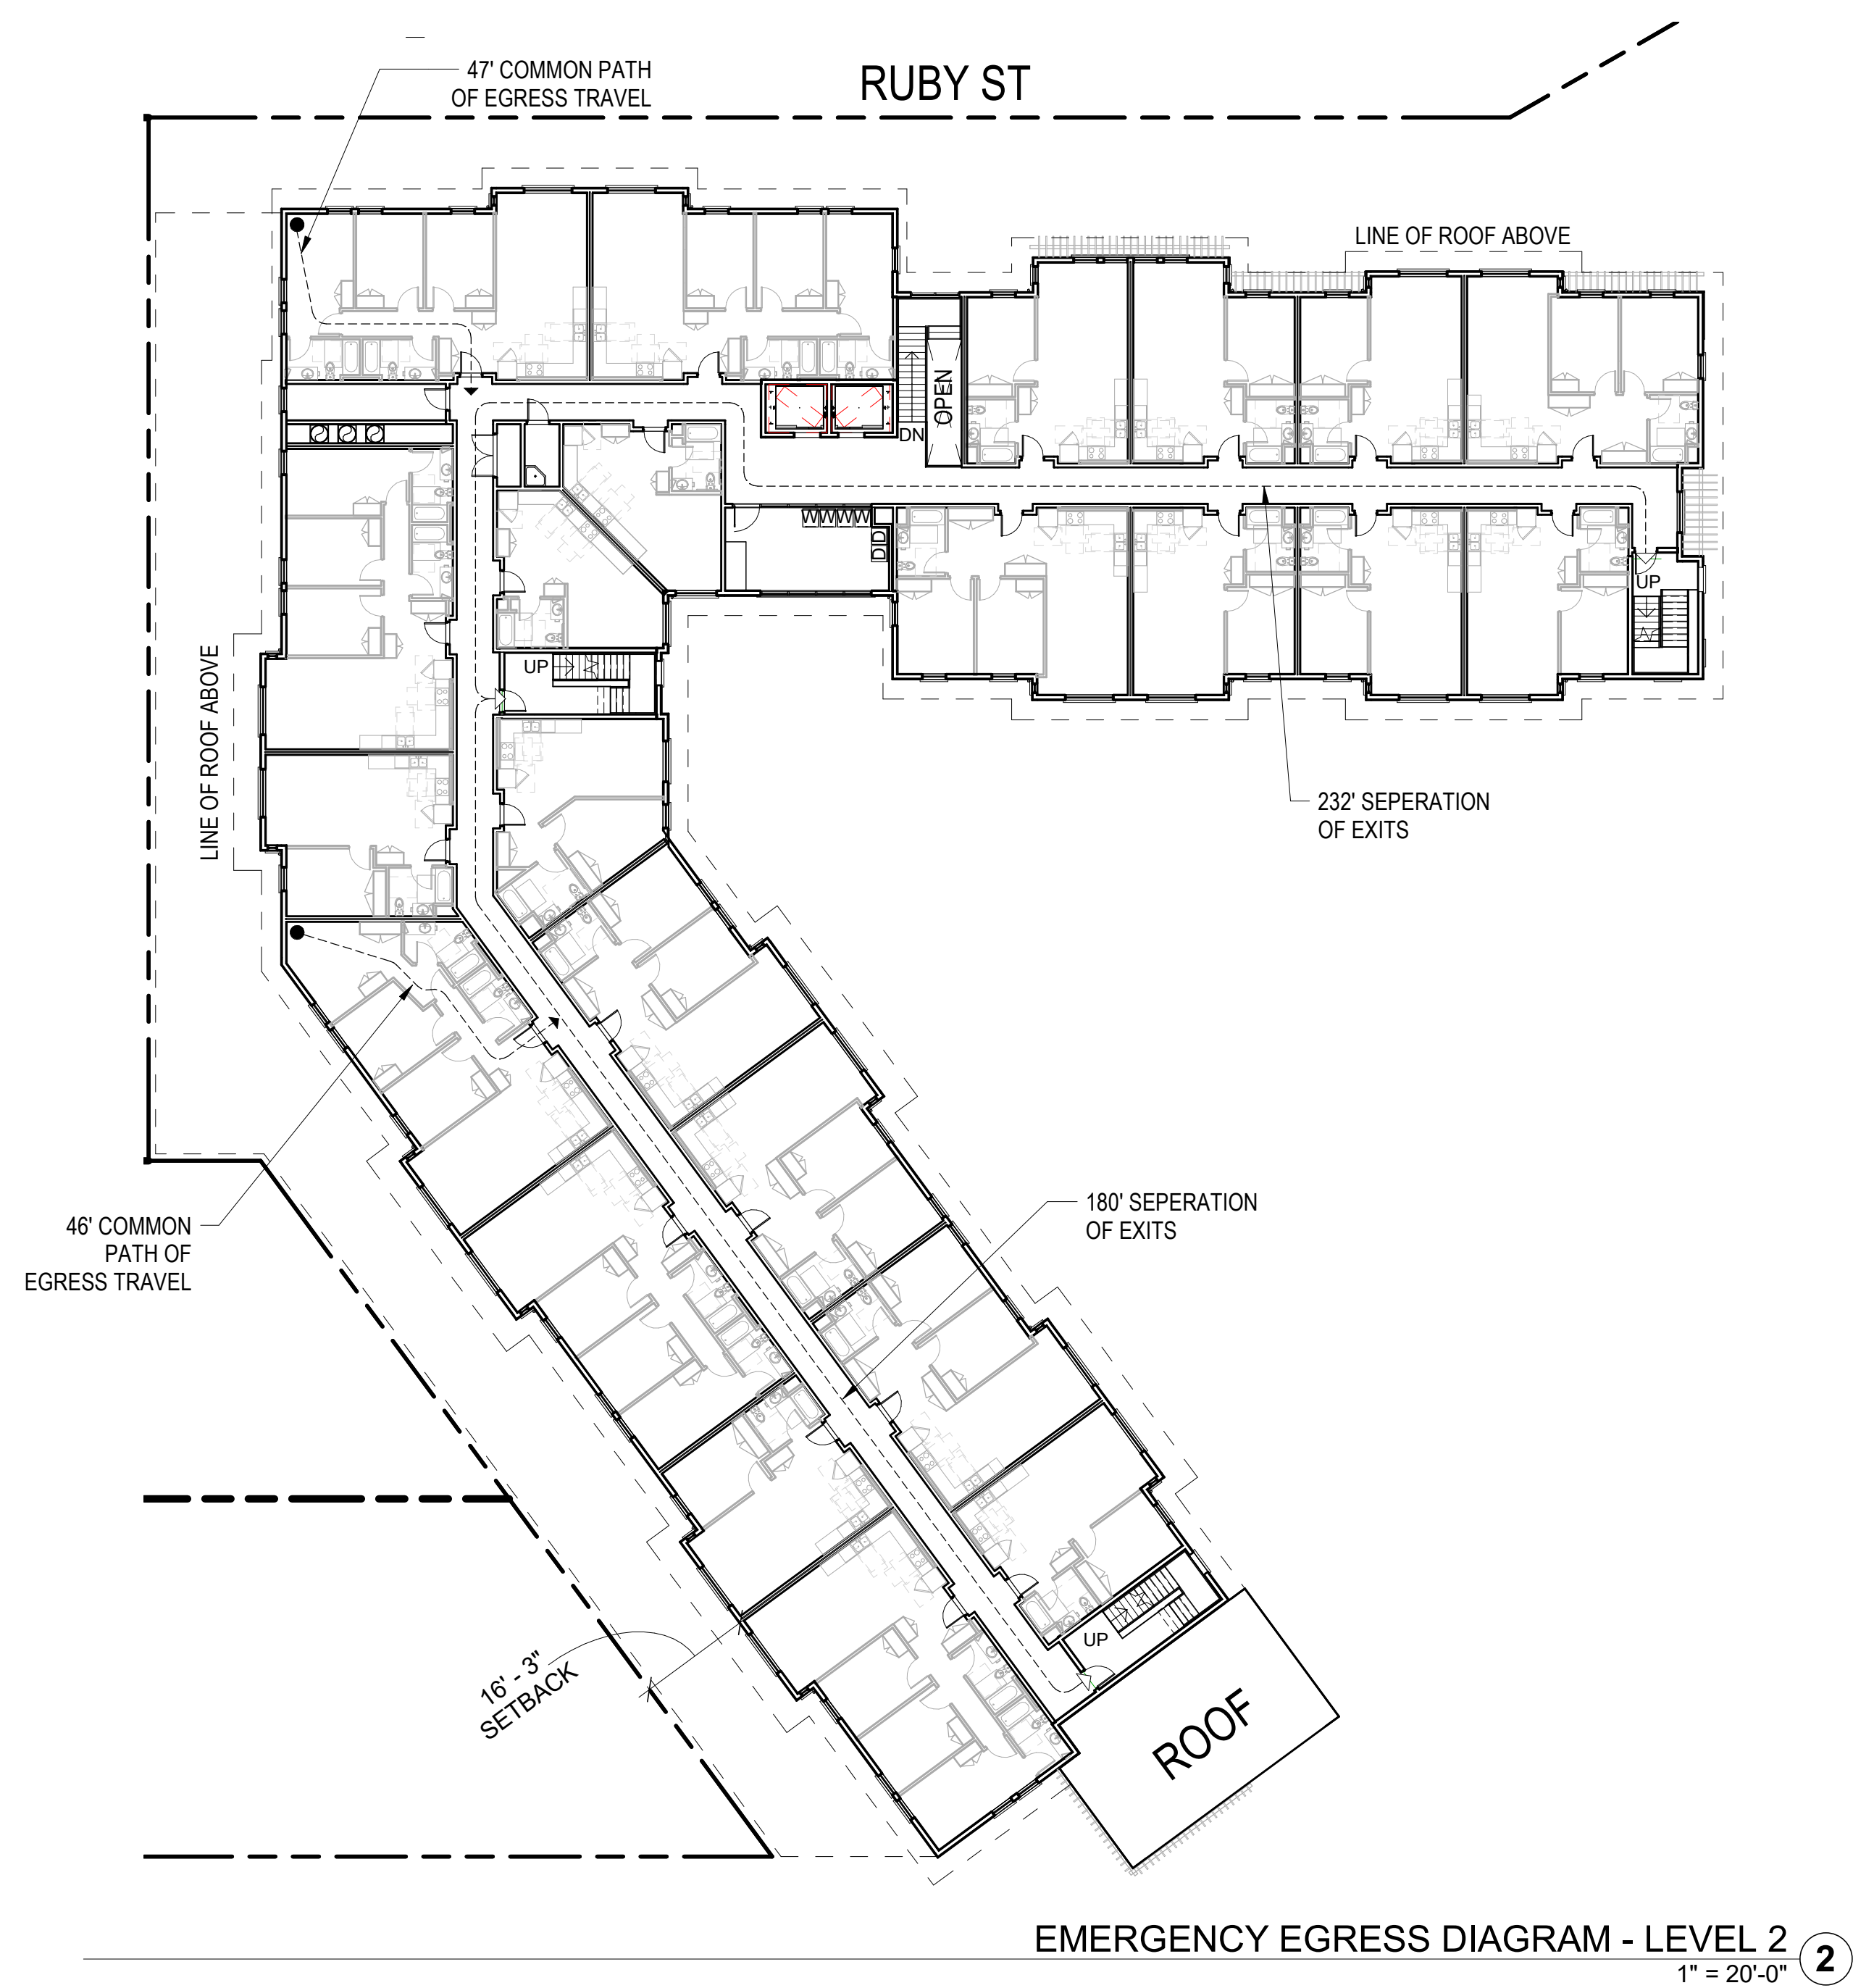
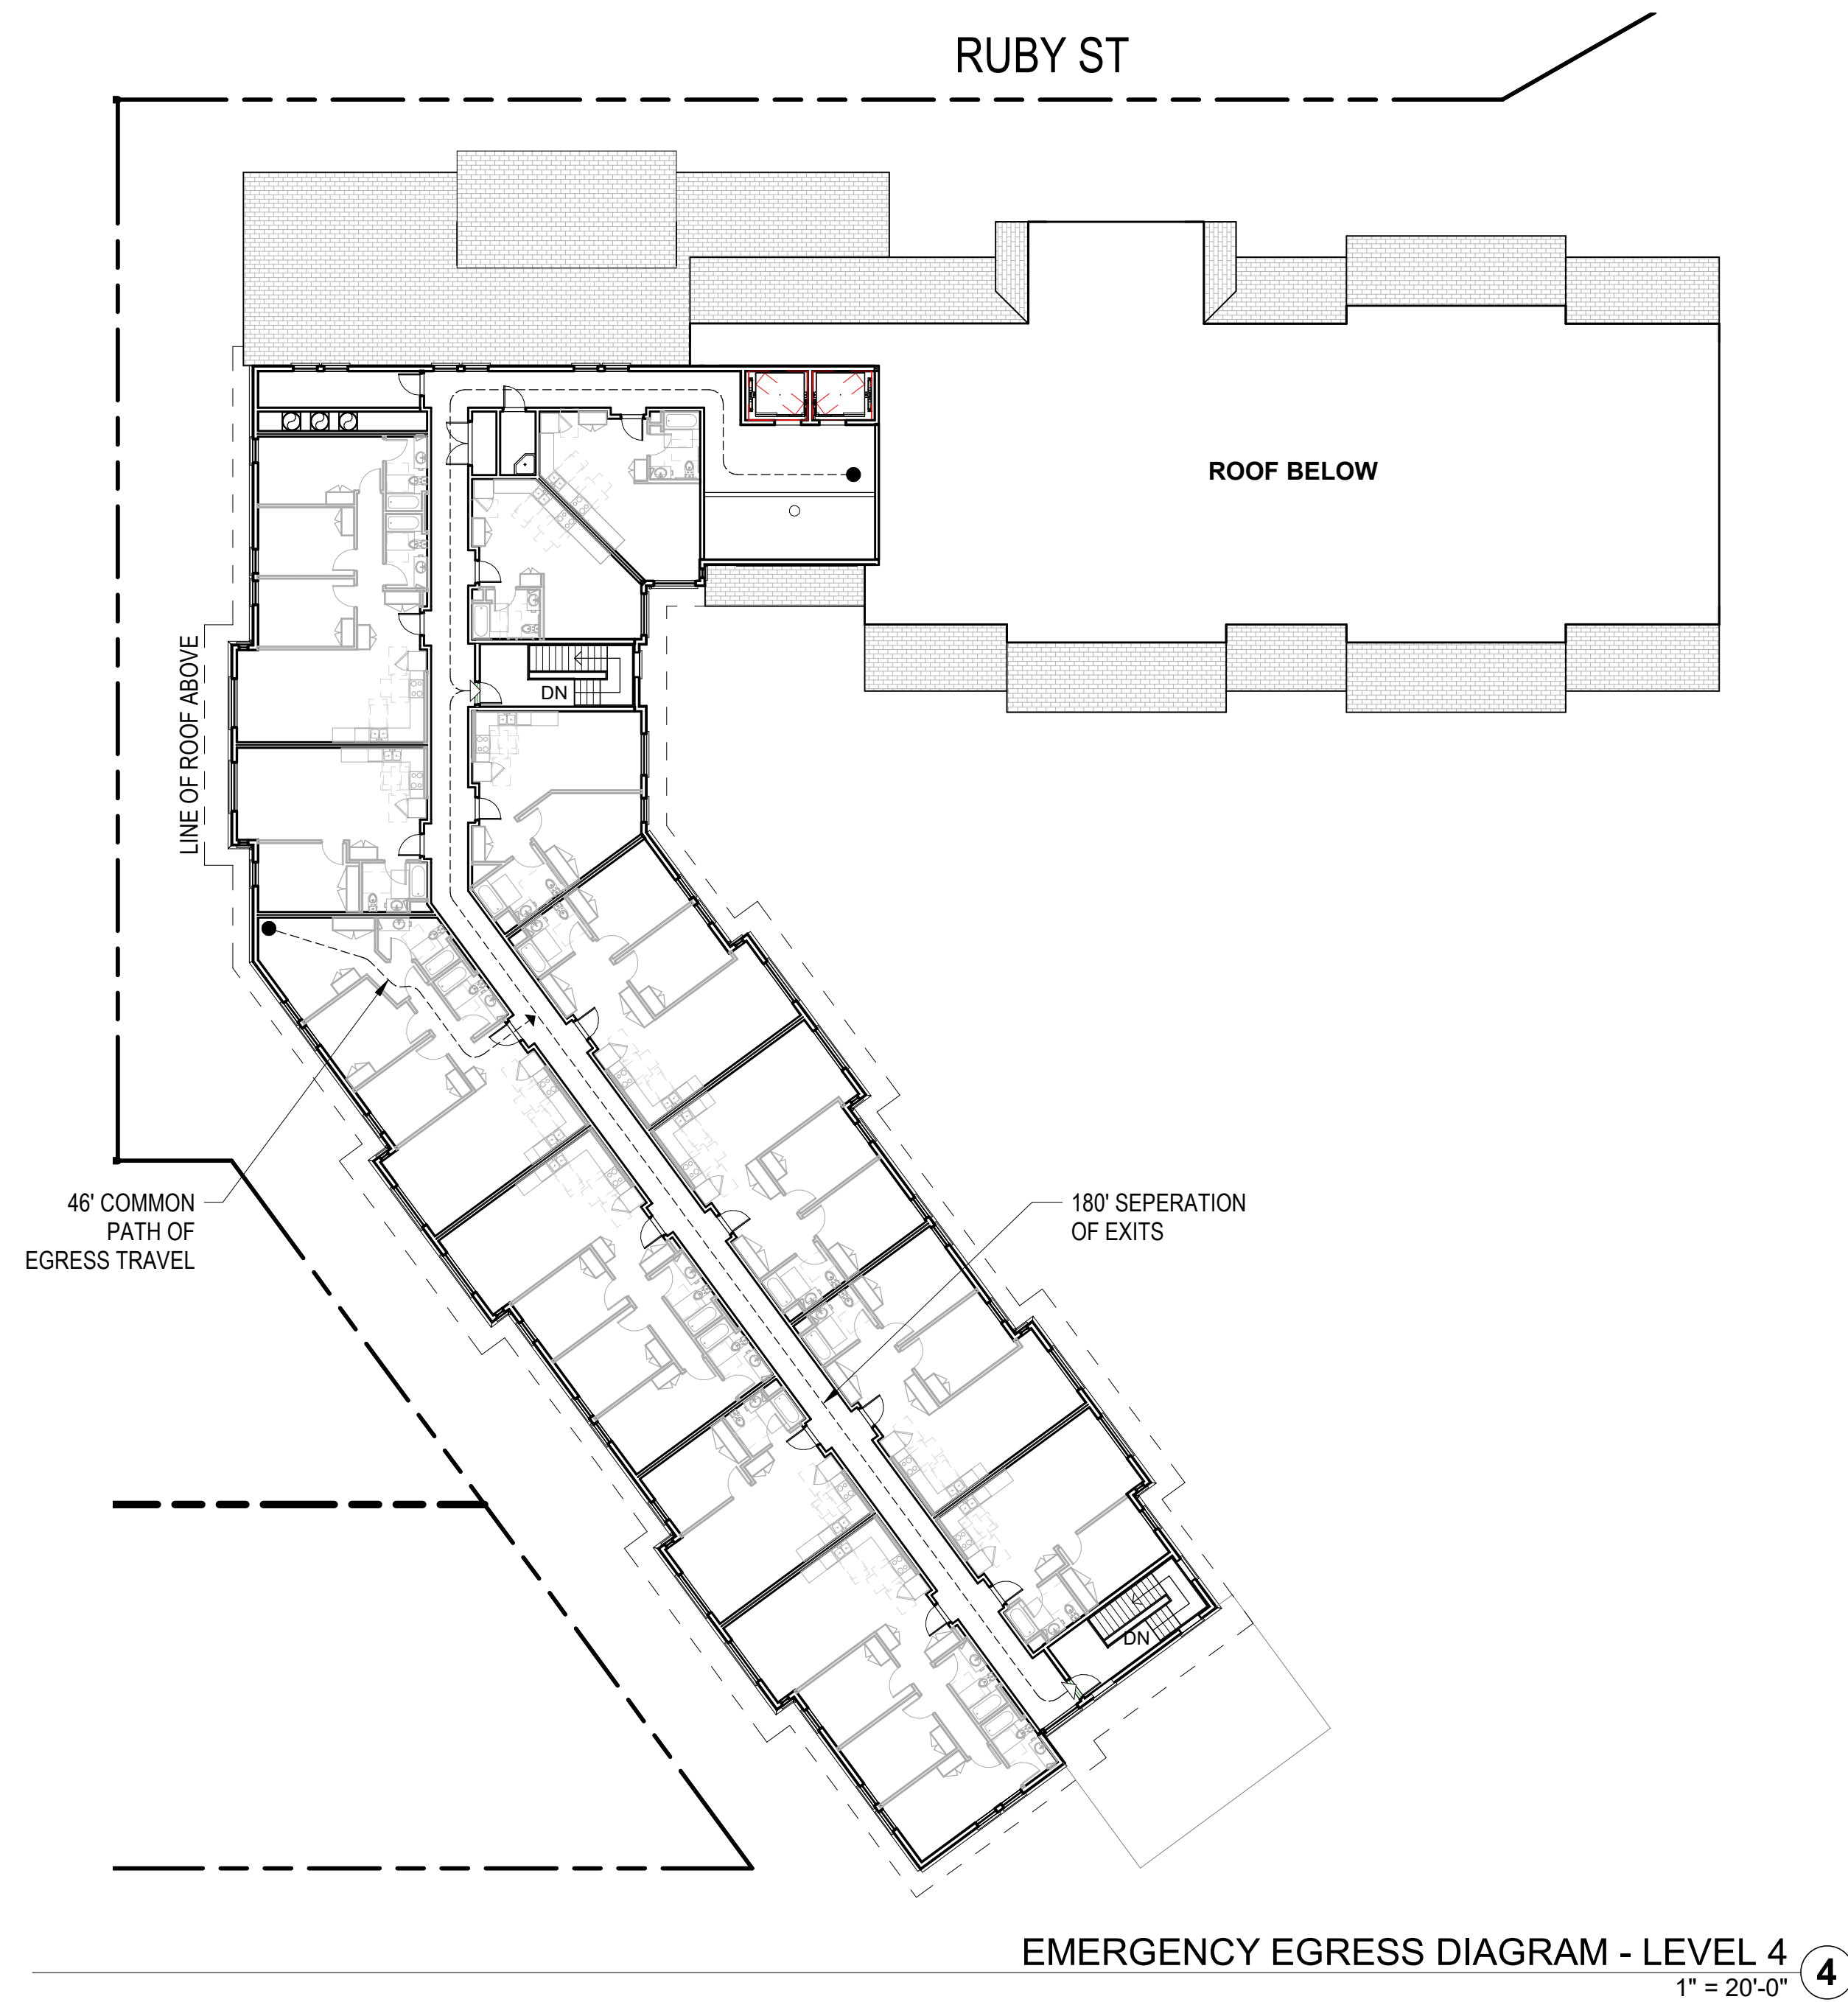
REVISION SCHEDULE
NO. | ISSUE | DATE

JOB NUMBER: 1744
DRAWN BY: KJ
CHECKED BY: CC
DATE: 01/27/2020
SCALE: As indicated
TITLE:

FIRE ACCESS DIAGRAMS

SHEET:

G0.01



LEGAL DESCRIPTION

REAL PROPERTY IN THE UNINCORPORATED AREA OF THE COUNTY OF ALAMEDA, STATE OF CALIFORNIA, DESCRIBED AS FOLLOWS:

PARCEL ONE:

LOTS 11 AND 12, IN BLOCK "M", AS SAID LOTS AND BLOCK ARE SHOWN ON THE "MAP OF THE KNOX TRACT, PROPERTIES OF MILO AND WM. KNOX, ADJACENT TO THE TOWN OF HAYWARD, ALAMEDA CO., CALIFORNIA", FILED JUNE 18, 1892, IN BOOK 17 OF MAPS, PAGE 87, IN THE OFFICE OF THE COUNTY RECORDER OF ALAMEDA COUNTY.

APN NO: 415-0230-013

PARCEL TWO:

LOT 10 IN BLOCK "M", OF THE KNOX TRACT, ACCORDING TO THE MAP THEREOF FILED JUNE 18, 1892, IN BOOK 17 OF MAPS, PAGE 87, IN THE OFFICE OF THE COUNTY RECORDER OF ALAMEDA COUNTY.

APN NO: 415-0230-014

PARCEL THREE:

LOT NO. 8 IN BLOCK LETTERED M AS SAID LOT AND BLOCK ARE SHOWN ON THE "MAP OF THE KNOX TRACT, PROPERTIES OF MILO AND WM. KNOX, ADJACENT TO THE TOWN OF HAYWARD, ALAMEDA CO., CALIFORNIA", FILED JUNE 18, 1892 IN BOOK 17 OF MAPS PAGE 87, IN THE OFFICE OF THE COUNTY RECORDER OF ALAMEDA COUNTY.

APN NO: 415-0230-016

PARCEL FOUR:

LOT 3 IN BLOCK "M", AS SAID LOT AND BLOCK ARE SHOWN ON THE "MAP OF THE KNOX TRACT, PROPERTIES OF MILO AND WM. KNOX, ADJACENT TO THE TOWN OF HAYWARD, ALAMEDA CO. CALIFORNIA", FILED JUNE 18, 1892, IN BOOK 17 OF MAPS, AT PAGE 87, IN THE OFFICE OF THE COUNTY RECORDER OF ALAMEDA COUNTY.

APN NO: 415-0230-015

PARCEL FIVE:

LOTS 6 AND 7, IN BLOCK "M", AS SAID LOTS AND BLOCK ARE SHOWN ON THE "MAP OF THE KNOX TRACT PROPERTIES OF MILO AND WM. KNOX ADJACENT TO THE TOWN OF HAYWARD, ALAMEDA CO., CALIFORNIA", FILED JUNE 18, 1892, IN BOOK 17 OF MAPS, PAGE 87, IN THE OFFICE OF THE COUNTY RECORDER OF ALAMEDA COUNTY.

APN NO: 415-0230-019 AND 415-0230-017

PARCEL SIX:

LOT 13, BLOCK M, MAP OF THE KNOX TRACT, PROPERTIES OF MILO AND WILLAM KNOX, ADJACENT TO THE TOWN OF HAYWARD, FILED JUNE 18, 1892, MAP BOOK 17, PAGE 87, ALAMEDA COUNTY RECORDS.

APN: 415-230-12

PARCEL SEVEN:

LOT 14, BLOCK M, MAP OF THE KNOX TRACT, PROPERTIES OF MILO AND WILLIAM KNOX ADJACENT TO THE TOWN OF HAYWARD, FILED JUNE 18, 1892, MAP BOOK 17, PAGE 87, ALAMEDA COUNTY RECORDS.

APN 415-230-11

PARCEL EIGHT:

PORTION OF LOT 1 IN BLOCK "M", AS SAID LOT AND BLOCK ARE SHOWN ON THE "MAP OF THE KNOX TRACT, PROPERTIES OF MILO AND WM. KNOX, ADJACENT TO THE TOWN OF HAYWARD, ALAMEDA CO., CALIFORNIA", FILED JUNE 18, 1892, IN BOOK 17 OF MAPS, PAGE 87, IN THE OFFICE OF THE COUNTY RECORDED OF ALABAMA COUNTY.

ALSO PORTION OF THE PARCEL OF LAND DESCRIBED IN THE GIFT DEED FROM MARY R. HANSON, A WIDOW, TO END A. ROSENBERG, DATED OCTOBER 18, 1921, RECORDED OCTOBER 27, 1921, IN BOOK 83 OF OFFICIAL RECORDS OF ALAMEDA COUNTY, PAGE 384, SAID PORTIONS BEING DESCRIBED AS FOLLOWS:

BEGINNING AT THE INTERSECTION OF THE NORTHWESTERN LINE OF THE COUNTY ROAD LEADING FROM HAYWARD TO CASTRO VALLEY, COMMONLY KNOWN AS "A" STREET, WITH THE INTERSECTION THEREOF WITH THE EASTERN CORNER OF SAID LOT 1 BLOCK "M", AS SAID LOT AND BLOCK ARE SHOWN ON SAID MAP; THENCE SOUTH 36° 09' WEST 86 FEET; THENCE NORTH 54° 07' WEST 117.13 FEET TO A POINT IN THE BED OF SAN LORENZO CREEK; THENCE ALONG THE BED OF SAID CREEK NORTH 1° 03' EAST 81.24 FEET; THENCE LEAVING THE BED OF SAID CREEK NORTHEASTERLY 50 FEET, MORE OR LESS TO THE NORTH - WEST CORNER OF SAID LOT 1; THENCE NORTH 54° 07' EAST 125.37 FEET TO THE POINT OF BEGINNING.

APN 415-230-023

PARCEL NINE:

LOT 2 BLOCK "M", AS SAID LOT AND BLOCK ARE SHOWN ON THAT CERTAIN MAP ENTITLED, "MAP OF THE KNOX TRACT, PROPERTIES OF MILO AND WM. KNOX, ADJACENT TO THE TOWN OF HAYWARD, ALAMEDA CO., CALIFORNIA", FILED JUNE 18, 1892, IN BLOCK 17 OF MAPS, AT PAGE 87, IN THE OFFICE OF THE COUNTY RECORDED OF ALAMEDA COUNTY.

APN 415-230-022

PARCEL TEN:

LOT 3 IN BLOCK "M", AS SAID LOT AND BLOCK ARE SHOWN ON THAT CERTAIN MAP ENTITLED, "MAP OF THE KNOX TRACT, PROPERTIES OF MILO AND WM. KNOX, ADJACENT TO THE TOWN OF HAYWARD, ALAMEDA CO., CALIFORNIA", FILED JUNE 18, 1892, IN BOOK 17 OF MAPS, AT PAGE 87, IN THE OFFICE OF THE COUNTY RECORDER OF ALAMEDA COUNTY.

APN: 415-0230-021

PARCEL ELEVEN:

PORTION OF LOT 20, IN BLOCK "M", AND A PORTION OF AN UNNUMBERED LOT, AS SHOWN ON THE "MAP OF THE KNOX TRACT, PROPERTIES OF MILO AND WM. KNOX ADJACENT TO THE TOWN OF HAYWARD, ALAMEDA CO., CALIFORNIA", FILED JUNE 18, 1892, IN BOOK 17 OF MAPS, AT PAGE 87, IN THE OFFICE OF THE COUNTY RECORDER OF ALAMEDA COUNTY, DESCRIBED AS FOLLOWS:

BEGINNING AT A POINT ON THE SOUTHWESTERN LINE OF SAID LOT 20, DISTANT THEREON SOUTH 50° 05' EAST 121.38 FEET FROM THE MOST WESTERN CORNER OF SAID LOT 20; AND RUNNING THENCE NORTH 72° 44' 15" 104.84 FEET; THENCE SOUTH 18° 58' 30" EAST 98.69 FEET; THENCE SOUTH 48° 06' 30" WEST 122.35 FEET TO THE SOUTHWESTERN LINE OF SAID

"KNOX TRACT", THENCE ALONG THE LAST NAMED LINE NORTH 26° 57' WEST 126.02 FEET TO AN ANGLE POINT THEREIN AT THE MOST EASTERN AT THE MOST EASTERN CORNER OF THE PARCEL OF LAND AWARDED TO HAYWARD UNION HIGH SCHOOL DISTRICT OF ALAMEDA COUNTY IN THE DECREE QUIETING TITLE CASE NO. 164714, DATED AUGUST 14, 1945, RECORDED AUGUST 27, 1945 IN BOOK 4772 OF OFFICIAL RECORDS OF ALAMEDA COUNTY, PAGE 33; THENCE ALONG THE NORTHEASTERN LINE OF THE LAST NAMED PARCEL NORTH 42° 39' 30" WEST 35 FEET, MORE OR LESS, TO A LINE DRAWN SOUTH 72° 44' 15" WEST FROM THE POINT OF BEGINNING, AND THENCE NORTH 72° 44' 15" EAST 35 FEET, MORE OR LESS, TO THE POINT OF BEGINNING.

APN: 415-230-070 & -069

LEGAL DESCRIPTION (CONT.)

PARCEL TWELVE:

PORTION OF LOT 20, IN BLOCK "M", AND A PORTION OF AN UNNUMBERED LOT, AS SHOWN ON THE "MAP OF THE KNOX TRACT, PROPERTIES OF MILO AND WM. KNOX, ADJACENT TO THE TOWN OF HAYWARD, ALAMEDA CO., CALIFORNIA", FILED JUNE 18, 1892, IN BOOK 17 OF MAPS, AT PAGE 87, IN THE OFFICE OF THE COUNTY RECORDER OF ALAMEDA COUNTY, DESCRIBED AS FOLLOWS:

BEGINNING AT THE INTERSECTION OF THE SOUTHERN LINE OF CRESCENT AVENUE, AS SHOWN ON SAID MAP, WITH THE SOUTHWESTERN LINE OF SAID LOT 20; AND RUNNING THENCE ALONG SAID SOUTHWESTERN LINE OF SAID LOT 20 SOUTH 50° 05' EAST 121.38 FEET; THENCE NORTH 72° 44' 15" EAST, 104.84 FEET; THENCE NORTH 20° 30' 40" WEST 78.63 FEET TO AN ANGLE POINT IN SAID SOUTHERN LINE OF CRESCENT AVENUE; AND THENCE ALONG THE LAST NAMED LINE SOUTH 80° 48' WEST 167.65 FEET TO THE POINT OF BEGINNING.

APN: 415-0230-002 AND 003 (A PORTION)

PARCEL THIRTEEN:

LOT 20 IN BLOCK "M", A SAID LOT AND BLOCK ARE SHOWN ON THE "MAP OF THE KNOX TRACT, PROPERTIES OF MILO AND WM. KNOX, ADJACENT TO THE TOWN OF HAYWARD, ALAMEDA CO., CALIFORNIA", FILED JUNE 18, 1892 IN BOOK 17 OF MAPS, PAGE 87, IN THE OFFICE OF THE COUNTY RECORDER OF ALAMEDA COUNTY.

EXCEPTING FROM PARCEL 13, A PARCEL OF LAND MORE PARTICULARLY DESCRIBED AS FOLLOWS:

BEGINNING AT A STAKE WHICH MARKS THE MOST WESTERN CORNER OF THE ABOVE MENTIONED LOT 20 IN BLOCK "M"; AND RUNNING THENCE SOUTH 56° 45' EAST DISTANT 31.32 FEET TO A STAKE; THENCE SOUTH 66° 26' EAST DISTANT 22.53 FEET TO A STAKE; THENCE SOUTH 16° 31' EAST DISTANT 18.10 FEET TO A STAKE ON THE SOUTHWESTERN LINE OF SAID LOT 20 IN BLOCK "M"; THENCE ALONG SAID LINE NORTH 50° 03' WEST, DISTANT 67.75 FEET TO THE POINT OF BEGINNING.

ALSO EXCEPTING FROM SAID PARCEL 13 THOSE PORTIONS THEREOF WHICH LIE WITHIN THE LINES OF PARCELS 11 AND 12 ABOVE DESCRIBED.

APN: 415-0230-005 (PORTION)

PARCEL FOURTEEN:

BEGINNING AT THE POINT OF INTERSECTION OF THE NORTHWESTERN LINE OF "A" STREET WITH THE NORTHWESTERN LINE OF COUNTY ROAD LEADING FROM HAYWARD TO CASTRO VALLEY; RUNNING THENCE NORTH 28° 57' WEST 53.4 FEET; THENCE NORTH 1° 3' EAST 180.7 FEET; THENCE NORTH 18° 57' WEST 120 FEET TO A POINT IN THE BED OF SAN LORENZO CREEK AND THE ACTUAL POINT OF BEGINNING OF THE PARCEL OF LAND HEREIN DESCRIBED; THENCE ALONG THE BED OF SAID CREEK, NORTH 79° 57' WEST 100 FEET; THENCE SOUTH 63°

03' WEST, 115 FEET; THENCE SOUTH 43° 03' WEST, 133.4 FEET; THENCE NORTH 56° 57' WEST 133 FEET; THENCE NORTH 11° 57' WEST, 138 FEET; THENCE NORTH 26° 57' WEST FEET 130 FEET; THENCE NORTHWESTERLY IN A DIRECT LINE AND LEAVING THE BED OF SAID CREEK, A DISTANCE OF 146 FEET TO A POINT ON THE SOUTHERN LINE OF CRESCENT AVENUE, MIDWAY BETWEEN THE EXTREME EASTERN CORNER OF LOT 21 AND THE EXTREME WESTERN CORNER OF LOT 20 IN BLOCK "M", AS SAID AVENUE, LOTS AND BLOCK ARE SHOWN ON THE MAP HEREIN REFERRED TO; THENCE NORTH 80° 48' EAST ALONG SAID LINE OF CRESCENT AVENUE, 20 FEET TO THE MOST WESTERN CORNER OF SAID LOT 20; THENCE SOUTH 50° 05' EAST ALONG THE SOUTHWESTERN BOUNDARY LINE OF SAID LOT 20, 289.18 FEET; THENCE FOLLOWING THE SOUTHERN BOUNDARY LINE OF LOT 20, IN SAID BLOCK "M", SOUTH 8° 21' EAST 82 FEET; THENCE SOUTH 28° 23' EAST, 111.82 FEET; THENCE NORTH 52° 29' EAST 46.45 FEET; THENCE NORTH 4° 23' EAST 95.13 FEET; THENCE NORTH 22° 13' EAST 76 FEET; THENCE NORTH 87° 40' EAST, 150.00 FEET TO THE MOST WESTERN CORNER OF LOT 9 IN SAID BLOCK "M"; THENCE ALONG THE SOUTHWESTERN BOUNDARY LINE OF SAID LOT 9 AND ALONG THE SOUTHWESTERN BOUNDARY LINE OF LOT 8 IN SAID BLOCK "M", SOUTH 53° 46' EAST, 100 FEET; THENCE SOUTHWESTERLY IN A DIRECT LINE, 50 FEET, MORE OR LESS, TO THE POINT OF BEGINNING.

BEING A PORTION OF THE KNOX TRACT, AS SAID TRACT IS SHOWN ON THE MAP OF THE KNOX TRACT, PROPERTIES OF MILO AND WM. KNOX, ADJACENT TO THE TOWN OF HAYWARD, ALAMEDA CO., CALIFORNIA", FILED JUNE 18, 1892, IN BOOK 17 OF MAPS PAGE 87, IN THE OFFICE OF THE COUNTY RECORDER OF ALAMEDA COUNTY.

EXCEPTING FROM SAID PARCEL 14, THOSE PORTIONS THEREOF, WHICH LIES WITHIN THE BOUNDARY LINES OF PARCELS 11, 12, ABOVE DESCRIBED.

ALSO EXCEPTING FROM PARCEL 14 THAT PORTION THEREOF LIES WITHIN THE BOUNDARY LINE OF PARCEL 3 DESCRIBED IN THE GRANT DEED TO STATE OF CALIFORNIA, RECORDED JUNE 30, 1969, REEL 2431, IMAGE 353, ALAMEDA COUNTY RECORDS.

APN: 415-230-005 (REMANDER) AND 415-230-003 (REMANDER)

PARCEL FIFTEEN:

A PORTION OF LOT 1 IN BLOCK "M", AS SAID LOT AND BLOCK ARE SHOWN ON THE "MAP OF THE KNOX TRACT, PROPERTIES OF MILO AND WM. KNOX, ADJACENT TO THE TOWN OF HAYWARD, ALAMEDA CO., CALIFORNIA", FILED JUNE 18, 1892, IN BOOK 17 OF MAPS, PAGE 87, IN THE OFFICE OF THE COUNTY RECORDER OF ALAMEDA COUNTY, ALSO A PORTION OF THE PARCEL OF LAND DESCRIBED IN THE GIFT DEED FROM MARY R. HANSON, A WIDOW, TO END A. ROSENBERG, DATED OCTOBER 18, 1921, RECORDED OCTOBER 27, 1921, IN BOOK 83, OF OFFICIAL RECORDS OF ALAMEDA COUNTY, PAGE 384, SAID PORTIONS ARE DESCRIBED AS FOLLOWS:

BEGINNING AT THE INTERSECTION OF THE NORTHWESTERN LINE OF THE COUNTY ROAD FROM HAYWARD TO CASTRO VALLEY AS SAID ROAD IS SHOWN ON SAID MAP, WITH THE WESTERN LINE OF SAID LOT 1; RUNNING ALONG THE NORTHWESTERN LINE OF SAID COUNTY ROAD, SOUTH 36° 09' WEST 80 FEET TO THE NORTHWESTERN LINE OF "A" STREET AS SHOWN ON SAID MAP; THENCE NORTH 28° 57' WEST 53.4 FEET; THENCE NORTH 1° 03' EAST 119.46 FEET; THENCE SOUTH 54° 07' EAST 117.13 FEET TO THE NORTHWESTERN LINE OF SAID COUNTY ROAD; THENCE ALONG THE LAST SAID LINE, SOUTH 36° 09' WEST 40.23 FEET TO THE POINT OF BEGINNING.

APN: 415-0230-024

PARCEL SIXTEEN:

BEGINNING AT A POINT IN THE BED OF SAN LORENZO CREEK, FROM WHICH POINT BEARS SOUTH 1° 3' WEST 180.7 FEET AND SOUTH 28° 57' EAST, 53.4 FEET, AN ANGLE FORMED BY THE INTERSECTION OF THE NORTHWESTERN LINE OF "A" STREET AND THE NORTHWESTERN LINE OF THE COUNTY ROAD RUNNING FROM HAYWARD TO CASTRO VALLEY; THENCE ALONG Rev. NAT 8/24/15 Page 8 Order No. 54605-1518692-17

THE BED OF SAID CREEK NORTH 18° 57' WEST 120 FEET; THENCE NORTHEASTERLY IN A DIRECT LINE 50 FEET TO THE SOUTHWEST CORNER OF LOT 7 IN BLOCK M, AS SAID LOT AND BLOCK ARE SHOWN ON THE "MAP OF THE KNOX TRACT ETC., ADJACENT TO THE TOWN OF HAYWARD, ALAMEDA CO., CALIFORNIA", FILED JUNE 18, 1892 IN BOOK 17, OF MAPS, PAGE 87, IN THE OFFICE OF THE COUNTY RECORDER OF ALAMEDA COUNTY; THENCE SOUTH 37° 42' EAST, 39.44 FEET TO A STAKE; THENCE SOUTH 20° 40' EAST, 91.6 FEET TO A STAKE; THENCE SOUTH 9° 38' EAST, 18.02 FEET TO THE NORTHWESTERN CORNER OF LOT 7 BLOCK M OF SAID KNOX TRACT; THENCE SOUTHWESTERLY IN A DIRECT LINE LEAVING THE BANK OF SAID CREEK, 50 FEET TO THE POINT OF BEGINNING.

APN: 415-0230-018

LEGAL DESCRIPTION (CONT.)

PARCEL SEVENTEEN:

BEGINNING AT THE INTERSECTION OF THE NORTHWESTERN LINE OF "A" STREET WITH THE NORTHWESTERN LINE OF COUNTY ROAD LEADING FROM HAYWARD TO CASTRO VALLEY, SAID POINT BEING THE MOST EASTERN CORNER OF PLOT "C", AS SAID PLOT IS SHOWN ON THE MAP OF "SAN LORENZO TERRACE, HAYWARD, ALAMEDA CO., CAL.", FILED OCTOBER 31, 1911 IN THE OFFICE OF THE COUNTY RECORDER OF ALAMEDA COUNTY; RUNNING THENCE SOUTH 48° WEST ALONG SAID LINE OF "A" STREET, 25.4 FEET TO THE WESTERN BOUNDARY LINE OF SAID PLOT "C"; THENCE NORTH 28°45' WEST ALONG THE WESTERN BOUNDARY LINE OF SAID PLOT "C", 57 FEET; THENCE NORTH 01° WEST 201.78 FEET; THENCE NORTH 15°26' WEST 67.09 FEET; THENCE NORTH 69°45' WEST 107.34 FEET; THENCE SOUTH 48° WEST 270.00 FEET; THENCE NORTH 61° WEST 95.19 FEET; THENCE NORTH 42° WEST 200 FEET; THENCE NORTH 48° EAST, 115 FEET TO THE WESTERN BOUNDARY LINE OF THE KNOX TRACT, AS SAID BOUNDARY LINE IS SHOWN ON THE "MAP OF THE KNOX TRACT, PROPERTIES OF MILO AND WM. KNOX, ADJACENT TO THE TOWN OF HAYWARD, ALAMEDA CO., CALIFORNIA", FILED JUNE 18, 1892 IN BOOK 17 OF MAPS, PAGE 87, IN THE OFFICE OF THE COUNTY RECORDER OF ALAMEDA COUNTY; THENCE NORTH 26° 57' WEST ALONG THE LAST NAMED LINE 60 FEET TO THE NORTHEASTERN BOUNDARY LINE OF PLOT "C" ABOVE REFERRED TO; THENCE SOUTH 44° 22' EAST ALONG SAID NORTHEASTERN BOUNDARY LINE OF PLOT "C", 95 FEET, MORE OR LESS, TO AN ANGLE POINT THEREIN; THENCE SOUTH 9°18' WEST 122 FEET; THENCE SOUTH 54°42' EAST, 156 FEET; THENCE NORTH 44°58' EAST 225 FEET; THENCE SOUTH 74°42' EAST, 125 FEET TO THE NORTHWESTERN BOUNDARY LINE OF THAT CERTAIN PIECE OR PARCEL OF LAND CONVEYED BY EDWIN S. WARREN AND WIFE, TO J. G. HAUSCHLDT, BY DEED DATED JULY 18, 1921 AND RECORDED DECEMBER 23, 1921 IN BOOK 116 OF OFFICIAL RECORDS OF ALAMEDA COUNTY, PAGE 273; THENCE SOUTHWESTERLY ALONG THE LAST NAMED LINE TO THE MOST WESTERN CORNER OF SAID LAND CONVEYED TO J. G. HAUSCHLDT; THENCE SOUTH 18°57' EAST 120 FEET; THENCE SOUTH 1°03' WEST 180.7 FEET; THENCE SOUTH 28°57' EAST 53.4 FEET TO THE POINT OF BEGINNING.

BEING A PORTION OF PLOT "C", AS SAID PLOT IS SHOWN ON THE MAP OF "SAN LORENZO TERRACE", AND A PORTION OF THE KNOX TRACT ABOVE-REFERRED TO.

APN: 415-0230-072 & -073

GENERAL NOTES:

1. OWNER:	EDEN HOUSING 22645 GRAND STREET HAYWARD, CA 94541
2. SUBDIVIDER:	EDEN HOUSING 22645 GRAND STREET HAYWARD, CA 94541 ELLEN MORRIS
3. ENGINEER/SURVEYOR:	LUK AND ASSOCIATES 738 ALFRED NOBEL DRIVE HERCULES, CALIFORNIA 94547 JACQUELINE LUK PLS 8934
4. ASSESSOR'S PARCEL NO.:	415-0230-002, 415-0230-003, 415-0230-005, 415-0230-011, 415-0230-012, 415-0230-013, 415-0230-014, 415-0230-015, 415-0230-016, 415-0230-017, 415-0230-018, 415-0230-019, 415-0230-021, 415-0230-022, 415-0230-023, 415-0230-024, 415-0230-069, 415-0230-070, 415-0230-072, 415-0230-073
5. TOTAL AREA:	6.280 ACRES (273,557 S.F.)

NOTES

1. THE UTILITIES SHOWN HEREON ARE BY SURFACE OBSERVATION AND RECORD INFORMATION ONLY AND NO WARRANTY IS GIVEN HEREIN AS TO THEIR EXACT LOCATION. IT IS THE RESPONSIBILITY OF THE DEVELOPER AND/OR CONTRACTOR TO VERIFY THE EXACT LOCATION OF THE UTILITIES WITH THE APPROPRIATE UTILITY COMPANY OR AGENCY.

2. UTILITY JURISDICTIONS / PROVIDERS ARE AS FOLLOWS:
STORM DRAINS: ALAMEDA COUNTY
SANITARY SEWER: CASTRO VALLEY SANITARY DISTRICT
WATER: EAST BAY MUNICIPAL UTILITY DISTRICT
ELECTRICITY: PACIFIC GAS & ELECTRIC COMPANY
NATURAL GAS: PACIFIC GAS & ELECTRIC COMPANY

3. FLOOD ZONE DESIGNATION: THE PREMISES ARE LOCATED IN ZONE "X" (NO SHADING) DEFINED AS "AREAS DETERMINED TO BE OUTSIDE THE 0.2% ANNUAL CHANCE FLOOD PLAIN", AND ZONE "A" DEFINED AS SPECIAL FLOOD HAZARD AREAS SUBJECT TO INUNDATION BY THE 1% ANNUAL CHANCE FLOOD, NO BASE FLOOD ELEVATIONS DETERMINED, PER FLOOD INSURANCE RATE MAP COMMUNITY PANEL NO. 06001002876, EFFECTIVE DATE: AUGUST 3, 2009.

BASIS OF BEARING

THE BASIS OF BEARINGS OF THIS SURVEY IS BASED ON FOUND STREET MONUMENTS ALONG "A" STREET BETWEEN ROCKAWAY LINE AND RUBY STREET AS SHOWN ON THAT CERTAIN RECORD OF SURVEY, FILED AUGUST 7, 1973, IN BOOK 9 OF RECORDS OF SURVEY, AT PAGES 30-31, IN THE OFFICE OF THE COUNTY RECORDER OF ALAMEDA COUNTY, STATE OF CALIFORNIA. THE BEARING IS TAKEN AS NORTH 40°51'45" WEST PER CALIFORNIA DEPARTMENT OF TRANSPORTATION RIGHT OF WAY RECORD MAP R-167.3.

BENCHMARK

ELEVATIONS ARE BASED ON THE NORTH AMERICAN VERTICAL DATUM OF 1988 (NAVD 88).

EASEMENT NOTES

- E-1: STORM SEWER EASEMENT IN FAVOR OF COUNTY OF ALAMEDA, RECORDED SEPTEMBER 11, 1934, 3077 O.R. 372.
- E-2: POLE LINE EASEMENT IN FAVOR OF PG&E, RECORDED JULY 13, 1954, 7369 O.R. 591.
- E-3: HIGHWAY EASEMENT IN FAVOR OF COUNTY OF ALAMEDA, RECORDED MAY 20, 1959, 9033 O.R. 247.
- E-4: HIGHWAY EASEMENT IN FAVOR OF COUNTY OF ALAMEDA, RECORDED JUNE 11, 1959, 9056 O.R. 383.
- E-5: SLOPE EASEMENT IN FAVOR OF COUNTY OF ALAMEDA, RECORDED MAY 20, 1960, 91 O.R. 912.
- E-6: BRIDGE EASEMENT IN FAVOR OF COUNTY OF ALAMEDA, RECORDED MAY 20, 1960, 91 O.R. 916, AR 59629.
- E-7: SLOPE EASEMENT IN FAVOR OF COUNTY OF ALAMEDA, RECORDED JUNE 6, 1960, 120 O.R. 964.
- E-8: HIGHWAY EASEMENT IN FAVOR OF COUNTY OF ALAMEDA, RECORDED JUNE 8, 1960, 101 O.R. 660, AR66065.
- E-9: BRIDGE EASEMENT IN FAVOR OF COUNTY OF ALAMEDA, RECORDED JUNE 8, 1960, 101 O.R. 660, AR66065.

EXCEPTIONS

- [1] EASEMENT FOR WATER COURSE OVER THAT PORTION PREMISES WHICH MAY LIE WITHIN THE LINES OF SAN LORENZO CREEK, AND TO ANY CHANGES IN THE BOUNDARY LINES THEREOF, FROM NATURAL CAUSES ANY BY IMPERCEPTIBLE DEGREES (PLOTTED).
- [2] AN EASEMENT FOR A STORM SEWER AND APPURTENANCES AND INCIDENTAL PURPOSES, RECORDED SEPTEMBER 11, 1934 AS BOOK 3077, PAGE 372 OF OFFICIAL RECORDS, IN FAVOR OF THE COUNTY OF ALAMEDA, AFFECTS THE NORTHWESTERN PORTION OF PARCEL FOUR (EXC. 6 - PLOTTED).
- [3] AN EASEMENT FOR POLE LINE AND INCIDENTAL PURPOSES, RECORDED JULY 13, 1954 AS BOOK 7369, PAGE 591 OF OFFICIAL RECORDS, IN FAVOR OF PACIFIC GAS AND ELECTRIC COMPANY, CALIFORNIA CORPORATION, AFFECTS PARCEL THIRTEEN (EXC. 7 - PLOTTED).
- [4] AN EASEMENT FOR PUBLIC HIGHWAY AND INCIDENTAL PURPOSES, RECORDED MAY 20, 1959 AS INSTRUMENT NO. A059797 IN BOOK 9033, PAGE 247 OF OFFICIAL RECORDS, IN FAVOR OF THE COUNTY OF ALAMEDA, AFFECTS PARCELS EIGHT, NINE, TEN AND FIFTEEN (EXC. 8 - PLOTTED).
- [5] AN EASEMENT FOR PUBLIC HIGHWAY AND INCIDENTAL PURPOSES, RECORDED JUNE 11, 1959 AS INSTRUMENT NO. A0/69489 IN BOOK 9056, PAGE 383 OF OFFICIAL RECORDS, IN FAVOR OF COUNTY OF ALAMEDA, AFFECTS THE SOUTHEASTERN PORTION OF PREMISES ADJACENT AND PARALLEL TO "A" STREET (EXC. 9 - NOT PLOTTED).
- [6] AN EASEMENT FOR SLOPE AND INCIDENTAL PURPOSES, RECORDED MAY 20, 1960 AS INSTRUMENT NO. AR/59628 IN REEL 91, IMAGE 912 OF OFFICIAL RECORDS, IN FAVOR OF COUNTY OF ALAMEDA, AFFECTS THE EASTERLY CORNER OF PARCEL FIFTEEN (EXC. 10 - NOT PLOTTED).
- [7] AN EASEMENT FOR THE CONSTRUCTION, OPERATION AND MAINTENANCE OF A REINFORCED CONCRETE STEEL GIRDER BRIDGE AND INCIDENTAL PURPOSES, RECORDED MAY 20, 1960 AS INSTRUMENT NO. AR/59629 OF OFFICIAL RECORDS, IN FAVOR OF COUNTY OF ALAMEDA, AFFECTS A MAJOR PORTION OF PARCEL FIFTEEN (EXC. 11 - PLOTTED).
- [8] AN EASEMENT FOR SLOPE EASEMENT AND INCIDENTAL PURPOSES, RECORDED JUNE 7, 1960 AS INSTRUMENT NO. AR-78452 IN REEL 120, PAGE 964 OF OFFICIAL RECORDS, IN FAVOR OF COUNTY OF ALAMEDA, AFFECTS THE SOUTHEASTERN PORTION OF PREMISES LYING ADJACENT TO AND NORTHWEST OF EASEMENT SHOWN ABOVE AT EXCEPTIONS, AFFECTS PARCELS EIGHT, NINE, TEN AND FIFTEEN (EXC. 12 - PLOTTED).
- [9] AN EASEMENT FOR A PUBLIC HIGHWAY AND INCIDENTAL PURPOSES, RECORDED JUNE 8, 1960 AS INSTRUMENT NO. AR/66065 IN REEL 1001, IMAGE 662 OF OFFICIAL RECORDS, IN FAVOR OF COUNTY OF ALAMEDA, AFFECTS A SOUTHERLY PORTION OF PARCEL SEVENTEEN (EXC. 14 - PLOTTED).
- [10] AN EASEMENT FOR RETAINING WALLS AND ANY AND ALL STRUCTURES NECESSARY TO THE CONSTRUCTION, OPERATION AND MAINTENANCE OF A REINFORCED CONCRETE STEEL GIRDER BRIDGE, TOGETHER WITH THE RIGHT TO MAKE ALL EXCAVATIONS AND BACKFILL NECESSARY FOR SUCH STRUCTURE OR STRUCTURES AND INCIDENTAL PURPOSES, RECORDED JUNE 8, 1960 AS INSTRUMENT NO. AR/66065 IN REEL 1001, IMAGE 662 OF OFFICIAL RECORDS, IN FAVOR OF COUNTY OF ALAMEDA, AFFECTS A SOUTHERLY PORTION OF PARCEL SEVENTEEN (EXC. 14 - PLOTTED).
- [11] THE FACT THAT THE LAND LIES WITHIN THE BOUNDARIES OF THE EDEEN REDEVELOPMENT PROJECT AREA, AS DISCLOSED BY VARIOUS DOCUMENTS OF RECORD (EXC. 17 - NOT PLOTTABLE).

RECORD REFERENCES

(R1) RECORD OF SURVEY, FILED AUGUST 7, 1973, IN BOOK 9 OF RECORDS OF SURVEY, AT PAGES 30-31, IN THE OFFICE OF THE COUNTY RECORDER OF ALAMEDA COUNTY, STATE OF CALIFORNIA.


(R2) CALIFORNIA DEPARTMENT OF TRANSPORTATION RIGHT OF WAY RECORD MAP R-167.3.

SURVEYOR'S STATEMENT

THIS MAP CORRECTLY REPRESENTS A SURVEY MADE BY ME OR UNDER MY DIRECTION IN CONFORMANCE WITH THE REQUIREMENTS OF THE LAND SURVEYORS ACT ON DECEMBER 19, 2018.

Jacqueline Luk
JACQUELINE LUK P.L.S. 8934

DATE: DECEMBER 20, 2018

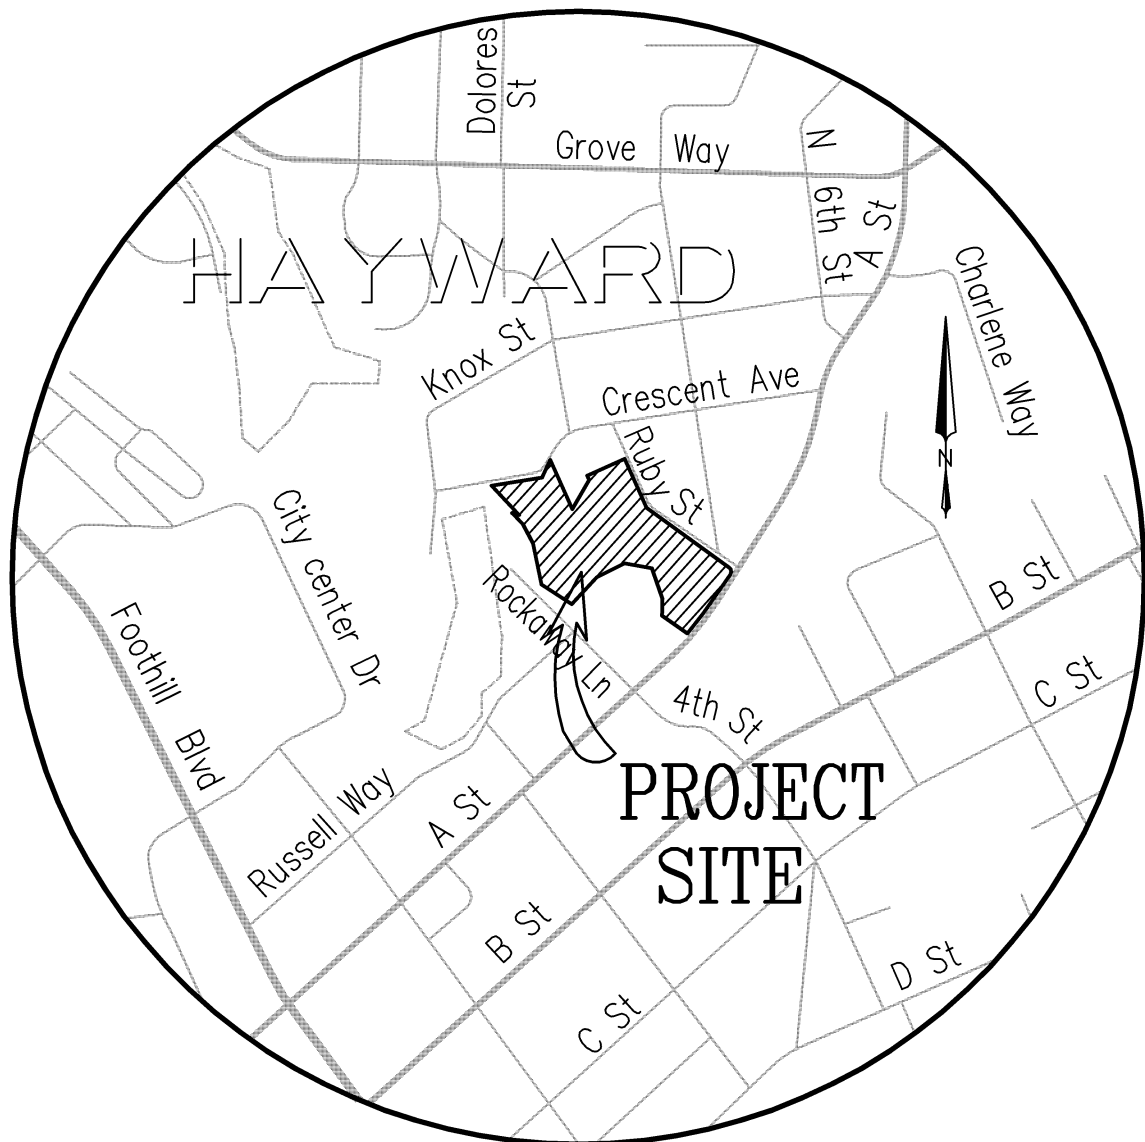

VICINITY MAP

NO SCALE

LOT LINE ADJUSTMENT


BEING THOSE PORTIONS OF LOTS 1-3, 6-14, AND 20 AND SAN LORENZO CREEK OF BLOCK "M" AS SHOWN ON THAT CERTAIN MAP ENTITLED "MAP OF THE KNOX TRACT" FILED ON JUNE 18, 1892, IN BOOK 17 OF MAPS, AT PAGE 87, AND A PORTION OF LOT "C" AS SHOWN ON THAT CERTAIN MAP ENTITLED " SAN LORENZO TERRACE, HAYWARD, ALAMEDA CO., CAL.", FILED OCTOBER 31, 1911 IN BOOK 26 OF MAPS, AT PAGE 52, ALL IN THE OFFICE OF THE COUNTY RECORDER OF ALAMEDA COUNTY, STATE OF CALIFORNIA

ALAMEDA COUNTY - CALIFORNIA

LUK AND ASSOCIATES

738 ALFRED NOBEL DRIVE
HERCULES, CALIFORNIA 94547

DECEMBER 2018

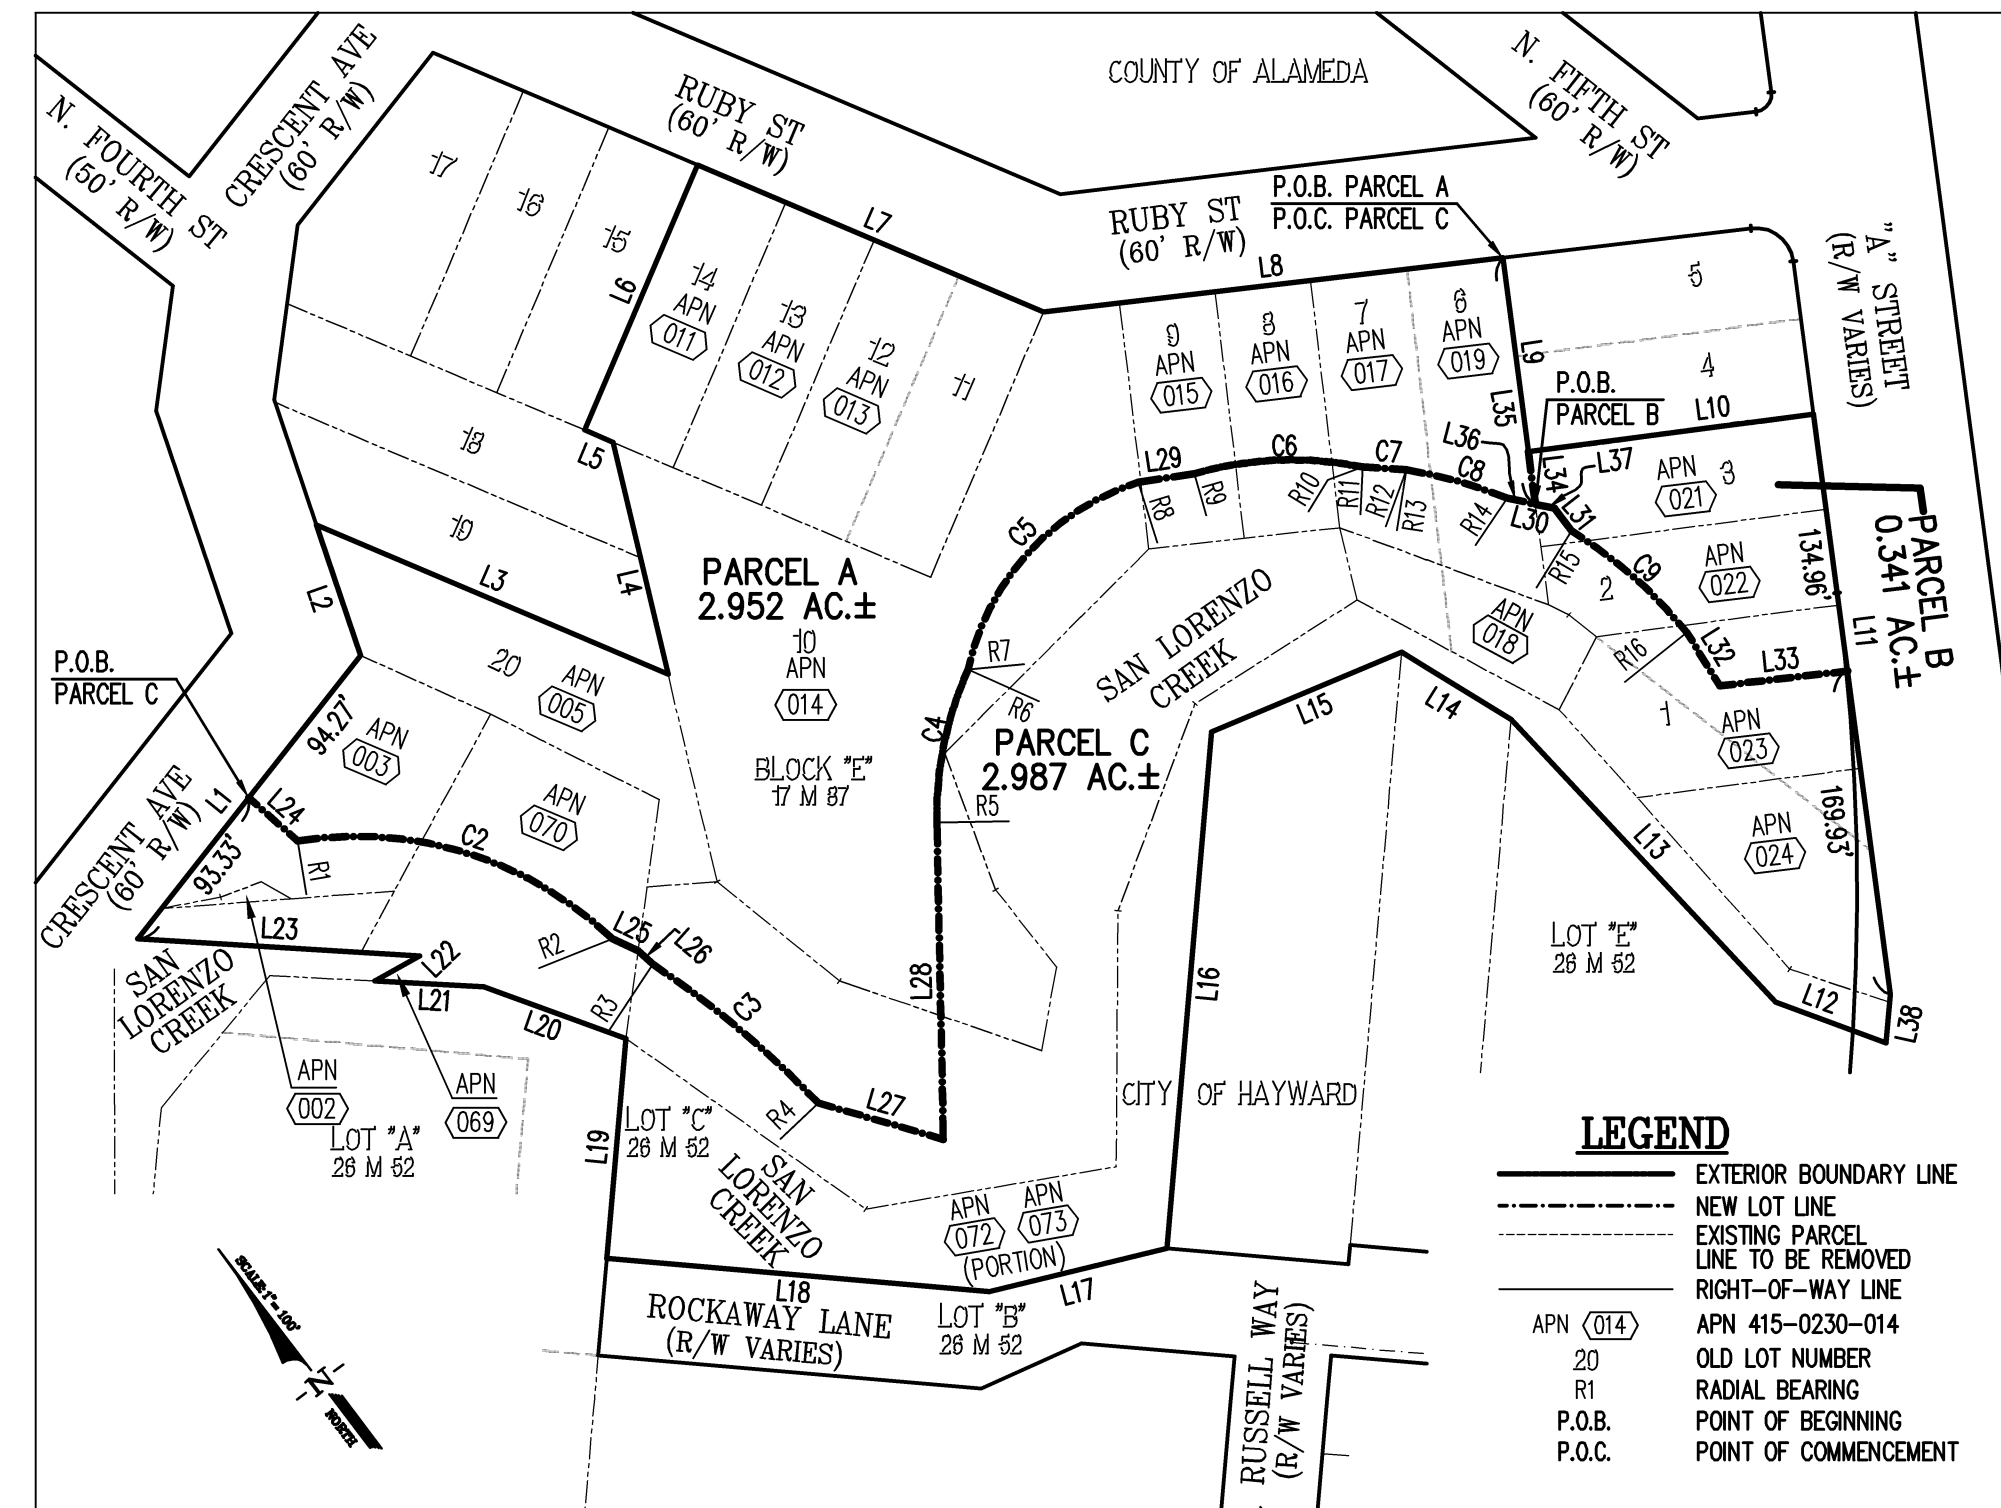

NEW LOT LINE DETAILS

SCALE: 1"=100'

LINE TABLE		
LINE	LENGTH	BEARING
L1	187.80	N85°22'15"E
L2	71.73	N52°27'55"E
L3	199.02	N22°47'10"W
L4	174.02	N35°51'20"E
L5	16.02	N22°47'10"W
L6	150.00	N67°12'50"E
L7	195.76	N22°47'10"W
L8	241.13	N52°34'10"W
L9	101.83	N35°18'45"W
L10	149.70	N53°18'45"W
L11	304.69	N36°41'04"E
L12	61.13	N52°36'45"E
L13	209.87	N01°07'22"E
L14	67.09	N14°17'48"W
L15	107.38	N65°37'15"W
L16	288.95	N46°08'15"E
L17	95.02	N59°28'57"W
L18	199.94	N42°51'45"W
L19	115.07	N40°08'15"E
L20	78.81	N25°48'45"W
L21	56.70	N42°47'45"W
L22	28.46	N75°07'45"W
L23	146.82	N42°15'21"E
L24	33.94	N04°20'28"W
L25	14.62	N07°41'25"W
L26	100.83	N63°51'41"W
L27	67.85	N02°40'37"W
L28	184.63	N42°59'28"E
L29	28.56	N54°36'54"W
L30	25.04	N33°35'56"W
L31	14.73	N06°46'58"E
L32	32.70	N12°22'50"E
L33	66.91	N15°22'30"W
L34	27.64	N36°41'15"E
L35	129.57	N36°41'15"E
L36	15.01	N33°35'56"W
L37	10.03	N33°35'56"W
L38	25.24	S49°08'00"W

CURVE TABLE			
CURVE	LENGTH	RADIUS	DELTA
C1	228.50	1204.85	105°15'59"
C2	178.00	183.00	52°46'37"
C3	112.52	504.77	12°46'18"
C4	81.04	185.00	25°24'35"
C5	137.96	131.54	60°06'11"
C6	86.80	185.00	27°28'26"
C7	22.78	508.83	02°33'56"
C8	54.81	233.26	13°27'47"
C9	81.47	233.26	19°36'17"

RADIAL BEARING	
R1	N35°33'37"E
R2	N87°53'14"E
R3	N77°47'36"E
R4	S62°05'25"E
R5	N47°00'32"W
R6	N01°05'59"W
R7	N15°34'36"W
R8	N08°31'35"E
R9	N08°13'42"E
R10	N52°40'08"E
R11	N46°51'41"E
R12	N49°27'40"E
R13	N53°04'14"E
R14	N63°30'10"E
R15	N75°45'13"E
R16	S84°28'29"E

NEW LOT LINE DIMENSIONS

NOTE



SEE SHEET 3 FOR LEGEND



LOT LINE ADJUSTMENT


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ALAMEDA COUNTY - CALIFORNIA
LUK AND ASSOCIATES
738 ALFRED NOBEL DRIVE
HERCULES, CALIFORNIA 94547
DECEMBER 2018

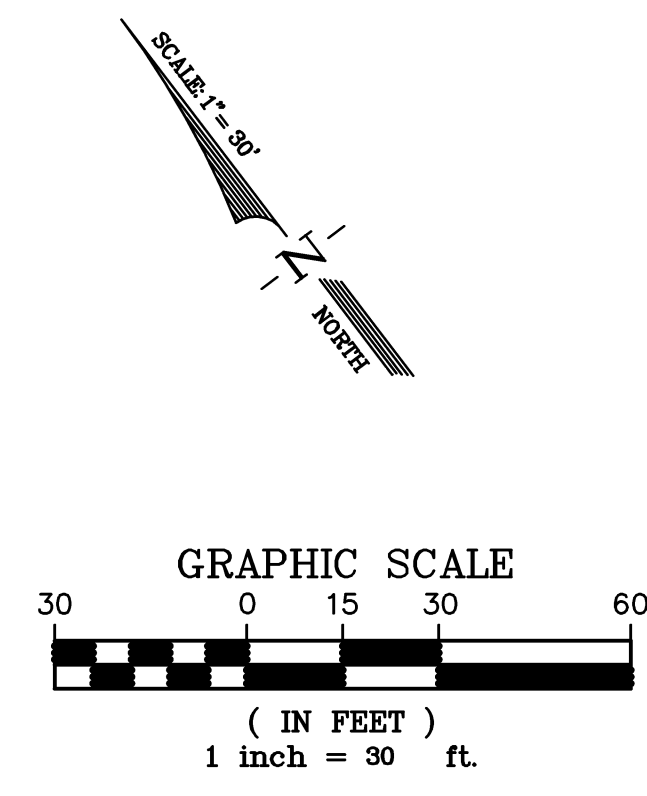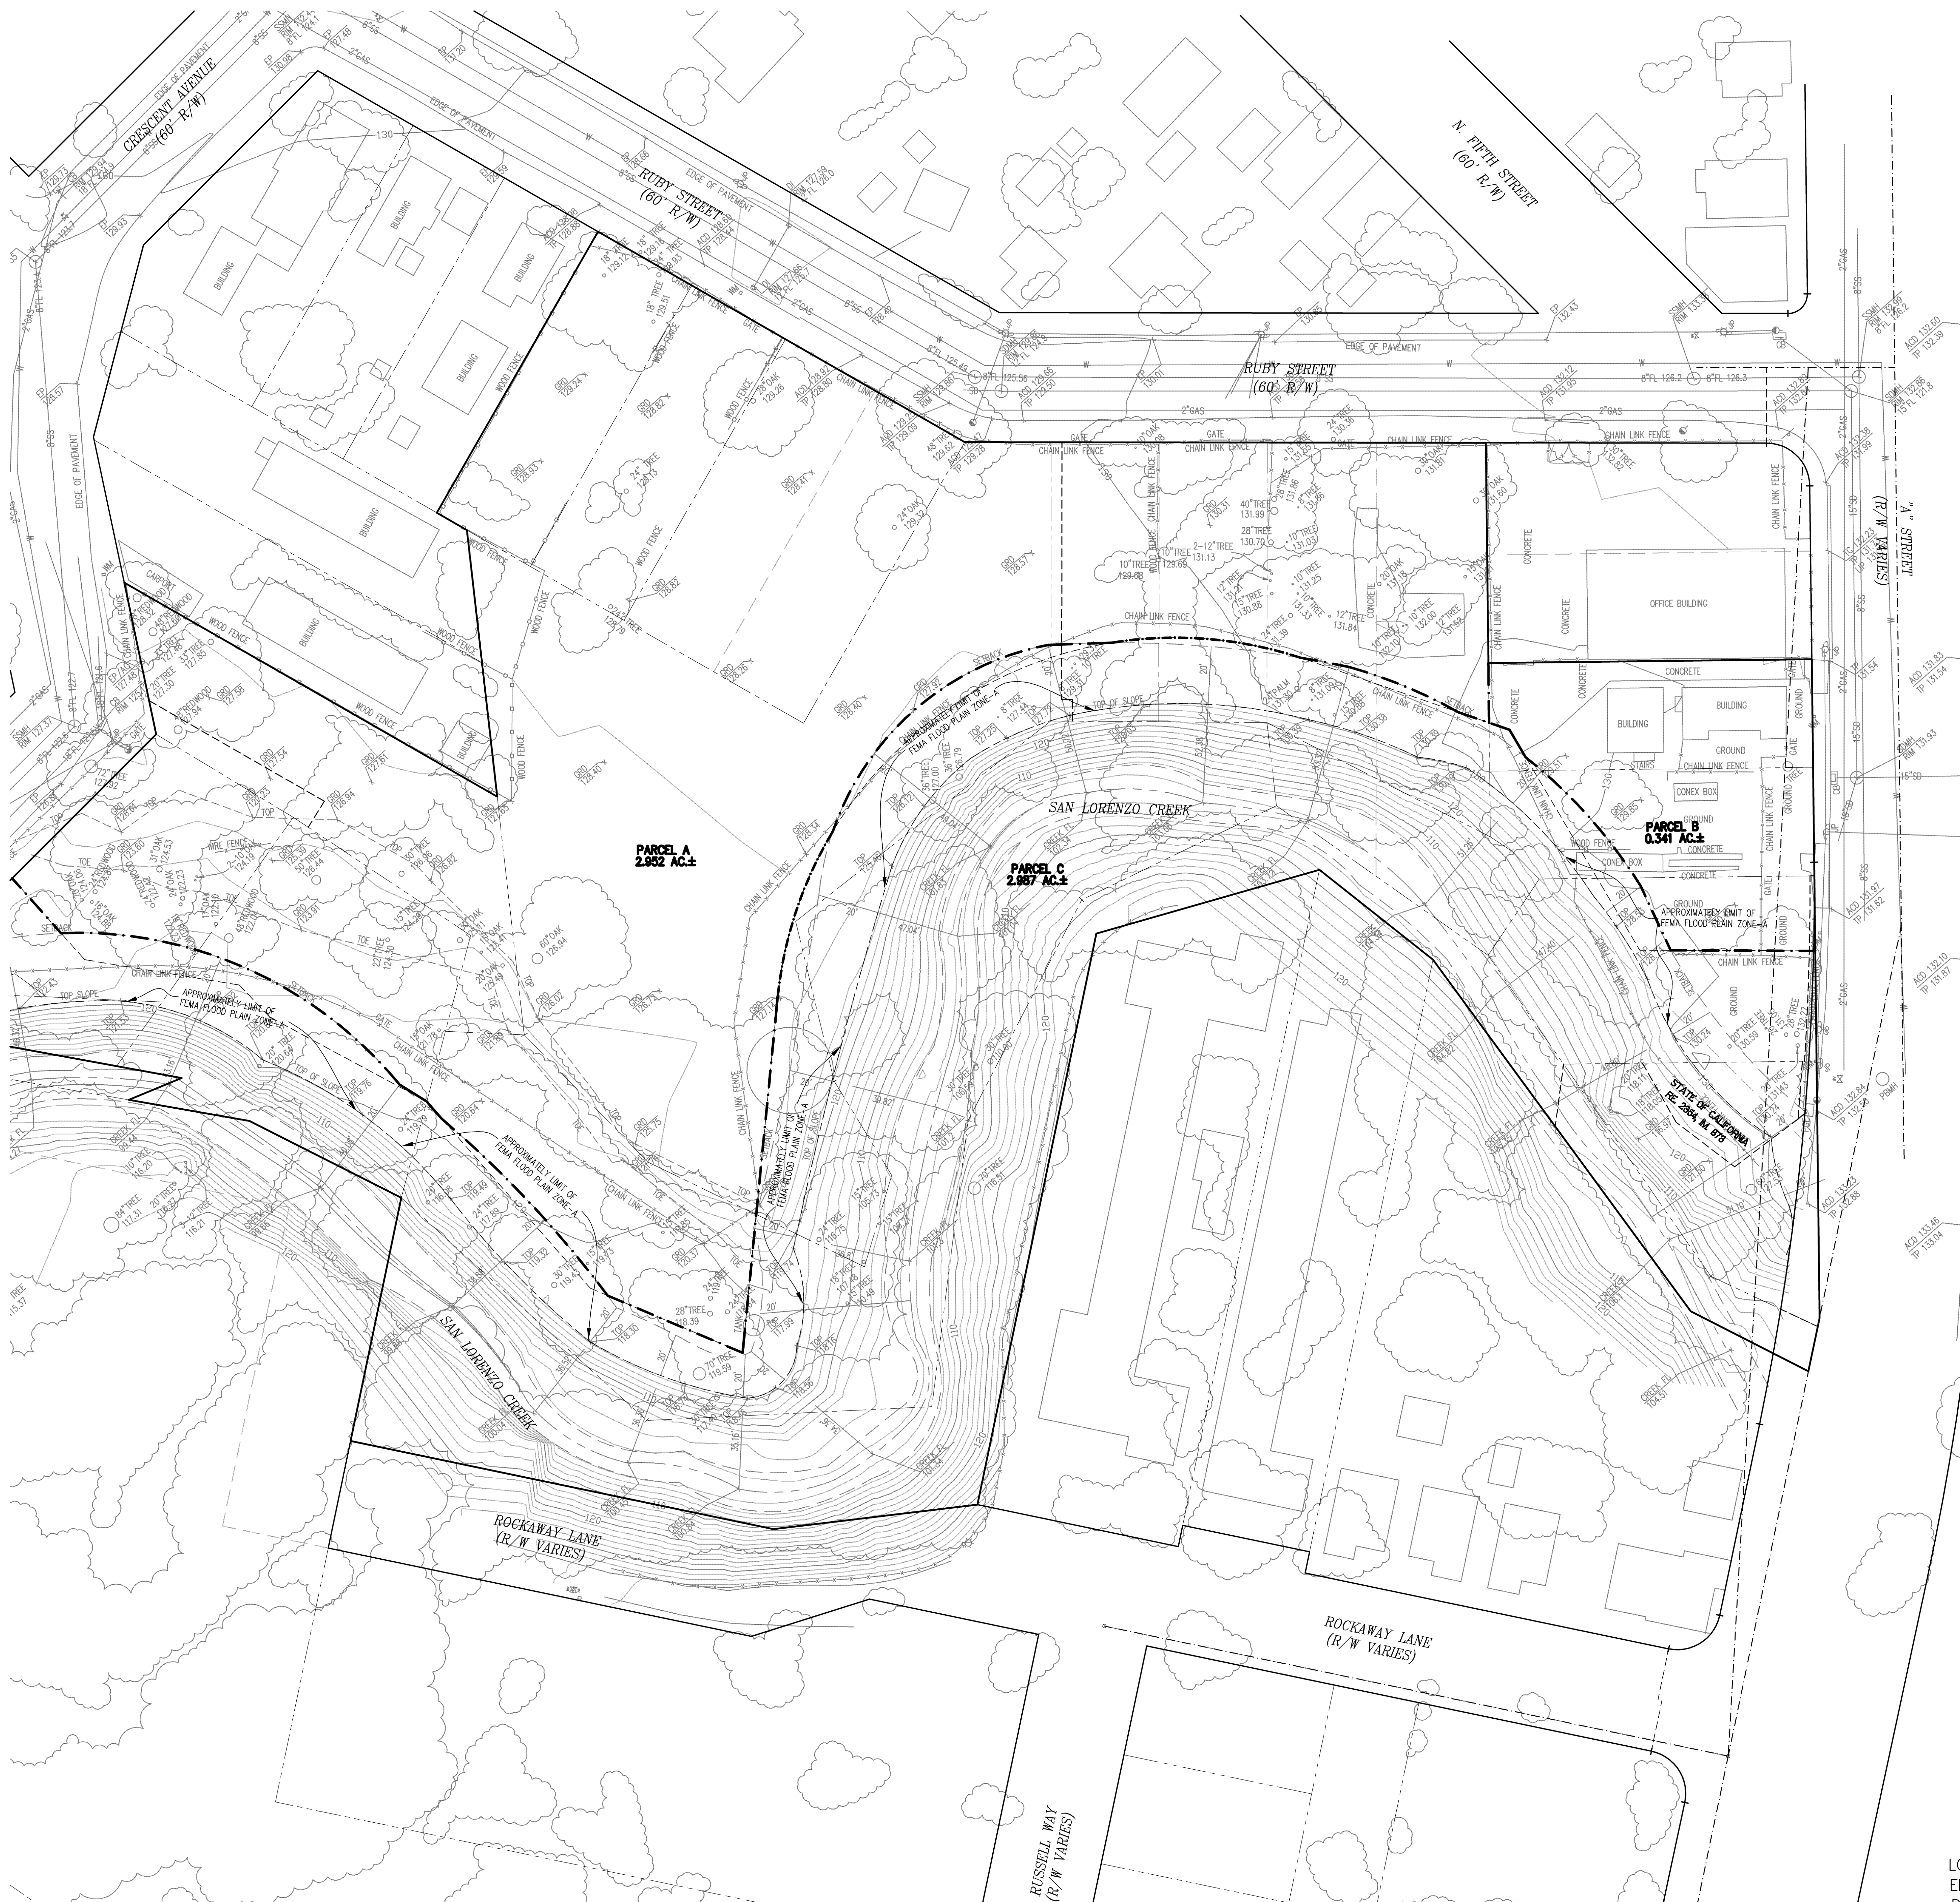

LEGEND	
SYMBOLS	DESCRIPTION
---	BOUNDARY - SUBJECT PROPERTY
---	RIGHT-OF-WAY LINE
---	EXISTING LOT LINE TO BE REMOVED
---	NEW LOT LINE
---	EASEMENT LINE
---	OLD LOT LINE TO BE REMOVED
---	MONUMENT LINE
---	CENTERLINE
---	TIE LINE
●	FOUND STREET MONUMENT AS NOTED
S.F.	SEARCH FOR AND NOT FOUND
±	SQUARE FEET
(R1)	MORE OR LESS
(R)	REFERENCE
(T)	RADIAL BEARING
	TOTAL
CALC.	CALCULATED VALUE
PTR	PRELIMINARY TITLE REPORT
R/W	RIGHT OF WAY
DOC. NO.	DOCUMENT NUMBER
(294.94')	RECORD DATA
APN	ASSESSOR'S PARCEL NUMBER
(M-M)	MONUMENT TO MONUMENT
(202.29')(R2)	RECORD DATA PER (R2)
(M-ML)	CONVERTED TO GROUND DISTANCE
E-1	MONUMENT TO MONUMENT LINE
	EASEMENT NOTE
	BUILDING LINE
	TOP / TOE
	ELECTROLER
	FOUND STANDARD CITY MONUMENT
	FIRE HYDRANT
	CATCH BASIN
	AREA DRAIN
	WATER VALVE
	WATER METER
	STORM DRAIN MANHOLE
	SANITARY SEWER CLEANOUT
	SANITARY SEWER MANHOLE
	TELEPHONE MANHOLE
	PACIFIC GAS AND ELECTRIC MANHOLE
	TREE
	ASPHALT CONCRETE
	FINISH FLOOR
	JOINT POLE
	TRAFFIC SIGNAL
	TRAFFIC SIGNAL BOX
	STREET LIGHT
	STREET LIGHT BOX
	PACIFIC GAS AND ELECTRIC BOX
	POWER POLE
	TELEVISION CABLE BOX
	CONCRETE
	UTILITY BOX
	ROOF DRAIN
	4" BOLLARD
	WATER BOX
	PARKING METER
	GAS VALVE
	WOOD FENCE
	CHAIN LINK FENCE
	SIGN
	CONCRETE ELEVATION
	GROUND ELEVATION
	TOP OF PAVEMENT ELEVATION
	TOP OF CURB ELEVATION
	BACK OF WALK ELEVATION
	FLOW LINE ELEVATION

LOT LINE ADJUSTMENT
BEING THOSE PORTIONS OF LOTS 1-3, 6-14, AND 20 AND SAN LORENZO CREEK OF BLOCK "M" AS SHOWN ON THAT CERTAIN MAP ENTITLED "MAP OF THE KNOX TRACT" FILED ON JUNE 18, 1892, IN BOOK 17 OF MAPS, AT PAGE 87, AND A PORTION OF LOT "C" AS SHOWN ON THAT CERTAIN MAP ENTITLED " SAN LORENZO TERRACE, HAYWARD, ALAMEDA CO., CAL.", FILED OCTOBER 31, 1911 IN BOOK 26 OF MAPS, AT PAGE 52, ALL IN THE OFFICE OF THE COUNTY RECORDER OF ALAMEDA COUNTY, STATE OF CALIFORNIA
ALAMEDA COUNTY - CALIFORNIA
LUK AND ASSOCIATES
738 ALFRED NOBEL DRIVE
HERCULES, CALIFORNIA 94547
DECEMBER 2018

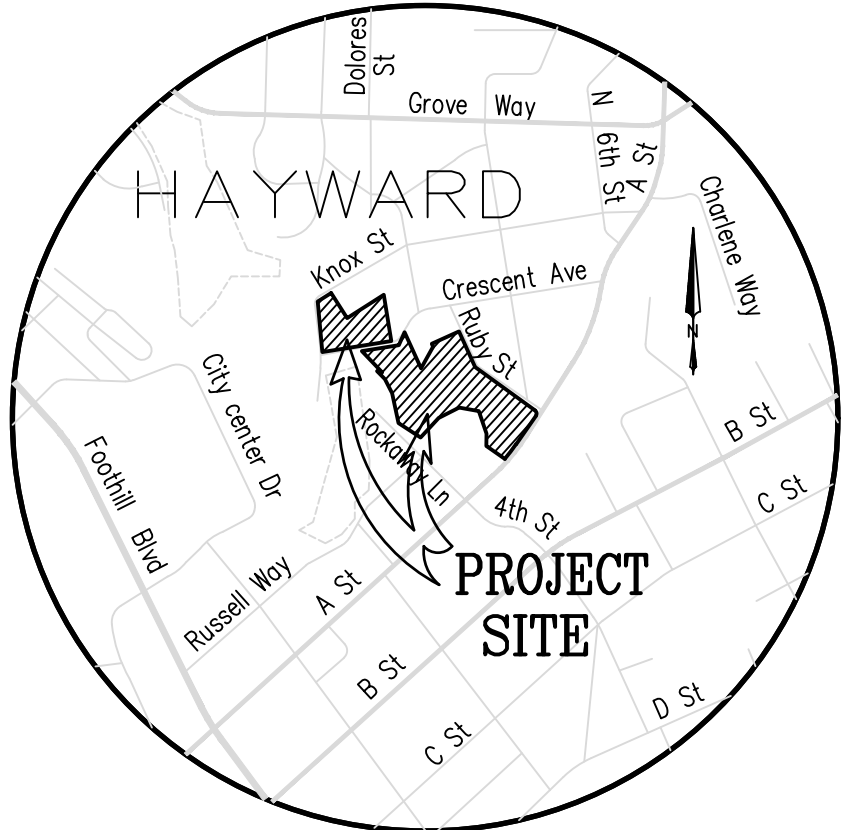

VICINITY MAP
NO SCALE

REFERENCES

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(R2) CALIFORNIA DEPARTMENT OF TRANSPORTATION RIGHT OF WAY RECORD MAP R-167.3.

BASIS OF BEARINGS

THE BASIS OF BEARINGS OF THIS SURVEY IS BASED ON FOUND STREET MONUMENTS ALONG "A" STREET BETWEEN ROCKAWAY LANE AND RUBY STREET AS SHOWN ON THAT CERTAIN RECORD OF SURVEY, FILED AUGUST 7, 1973, IN BOOK 9 OF RECORDS OF SURVEY, AT PAGES 30-31, IN THE OFFICE OF THE COUNTY RECORDER OF ALAMEDA COUNTY, STATE OF CALIFORNIA. THE BEARING IS TAKEN AS NORTH 40°51'45" WEST PER CALIFORNIA DEPARTMENT OF TRANSPORTATION RIGHT OF WAY RECORD MAP R-167.3.

BENCHMARK


ELEVATIONS ARE BASED ON THE NORTH AMERICAN VERTICAL DATUM OF 1988 (NAVD 88).

EASEMENT NOTES

- E-1: STORM SEWER EASEMENT IN FAVOR OF COUNTY OF ALAMEDA, RECORDED SEPTEMBER 11, 1934, 3077 O.R. 372
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- E-9: BRIDGE EASEMENT IN FAVOR OF COUNTY OF ALAMEDA, RECORDED JUNE 8, 1960, 101 O.R. 660, AR66065

NOTE

THIS BOUNDARY RETRACEMENT IS MAINLY BASED ON CALIFORNIA DEPARTMENT OF TRANSPORTATION RIGHT OF WAY RECORD MAP R-167.3.

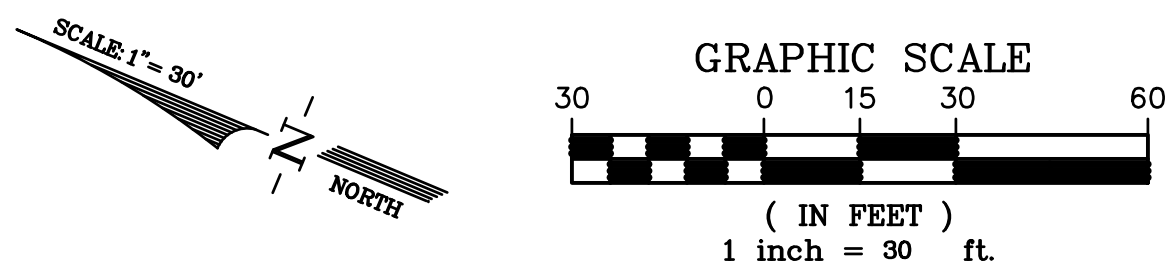

PYATOK
1611 TELEGRAPH AVE. SUITE 200
OAKLAND, CA 94612
510.465.7010 p | 510.465.8575 f
www.pyatok.com

EDEN HOUSING

22645 Grand St, Hayward, CA 94541

RUBY ST
Ruby St, Castro Valley, CA 94546

STAMP:

Luk and Associates
Civil Engineering
Land Planning
Land Surveying
738 Alfred Nobel Drive
Hercules, CA 94547
Phone (510) 724-3388
Fax (510) 724-3383

REVISION SCHEDULE	
No.	ISSUE

JOB NUMBER:	10004410
DRAWN BY:	CW
CHECKED BY:	J
DATE:	JANUARY 2019
SCALE:	1" = 30'

TITLE: TOPOGRAPHIC & BOUNDARY SURVEY


SHEET:

C-1.1

PRELIMINARY - Not for Construction -

© 2017 PYATOK ARCHITECTURE & URBAN DESIGN

Plot Date: 01-17-2020

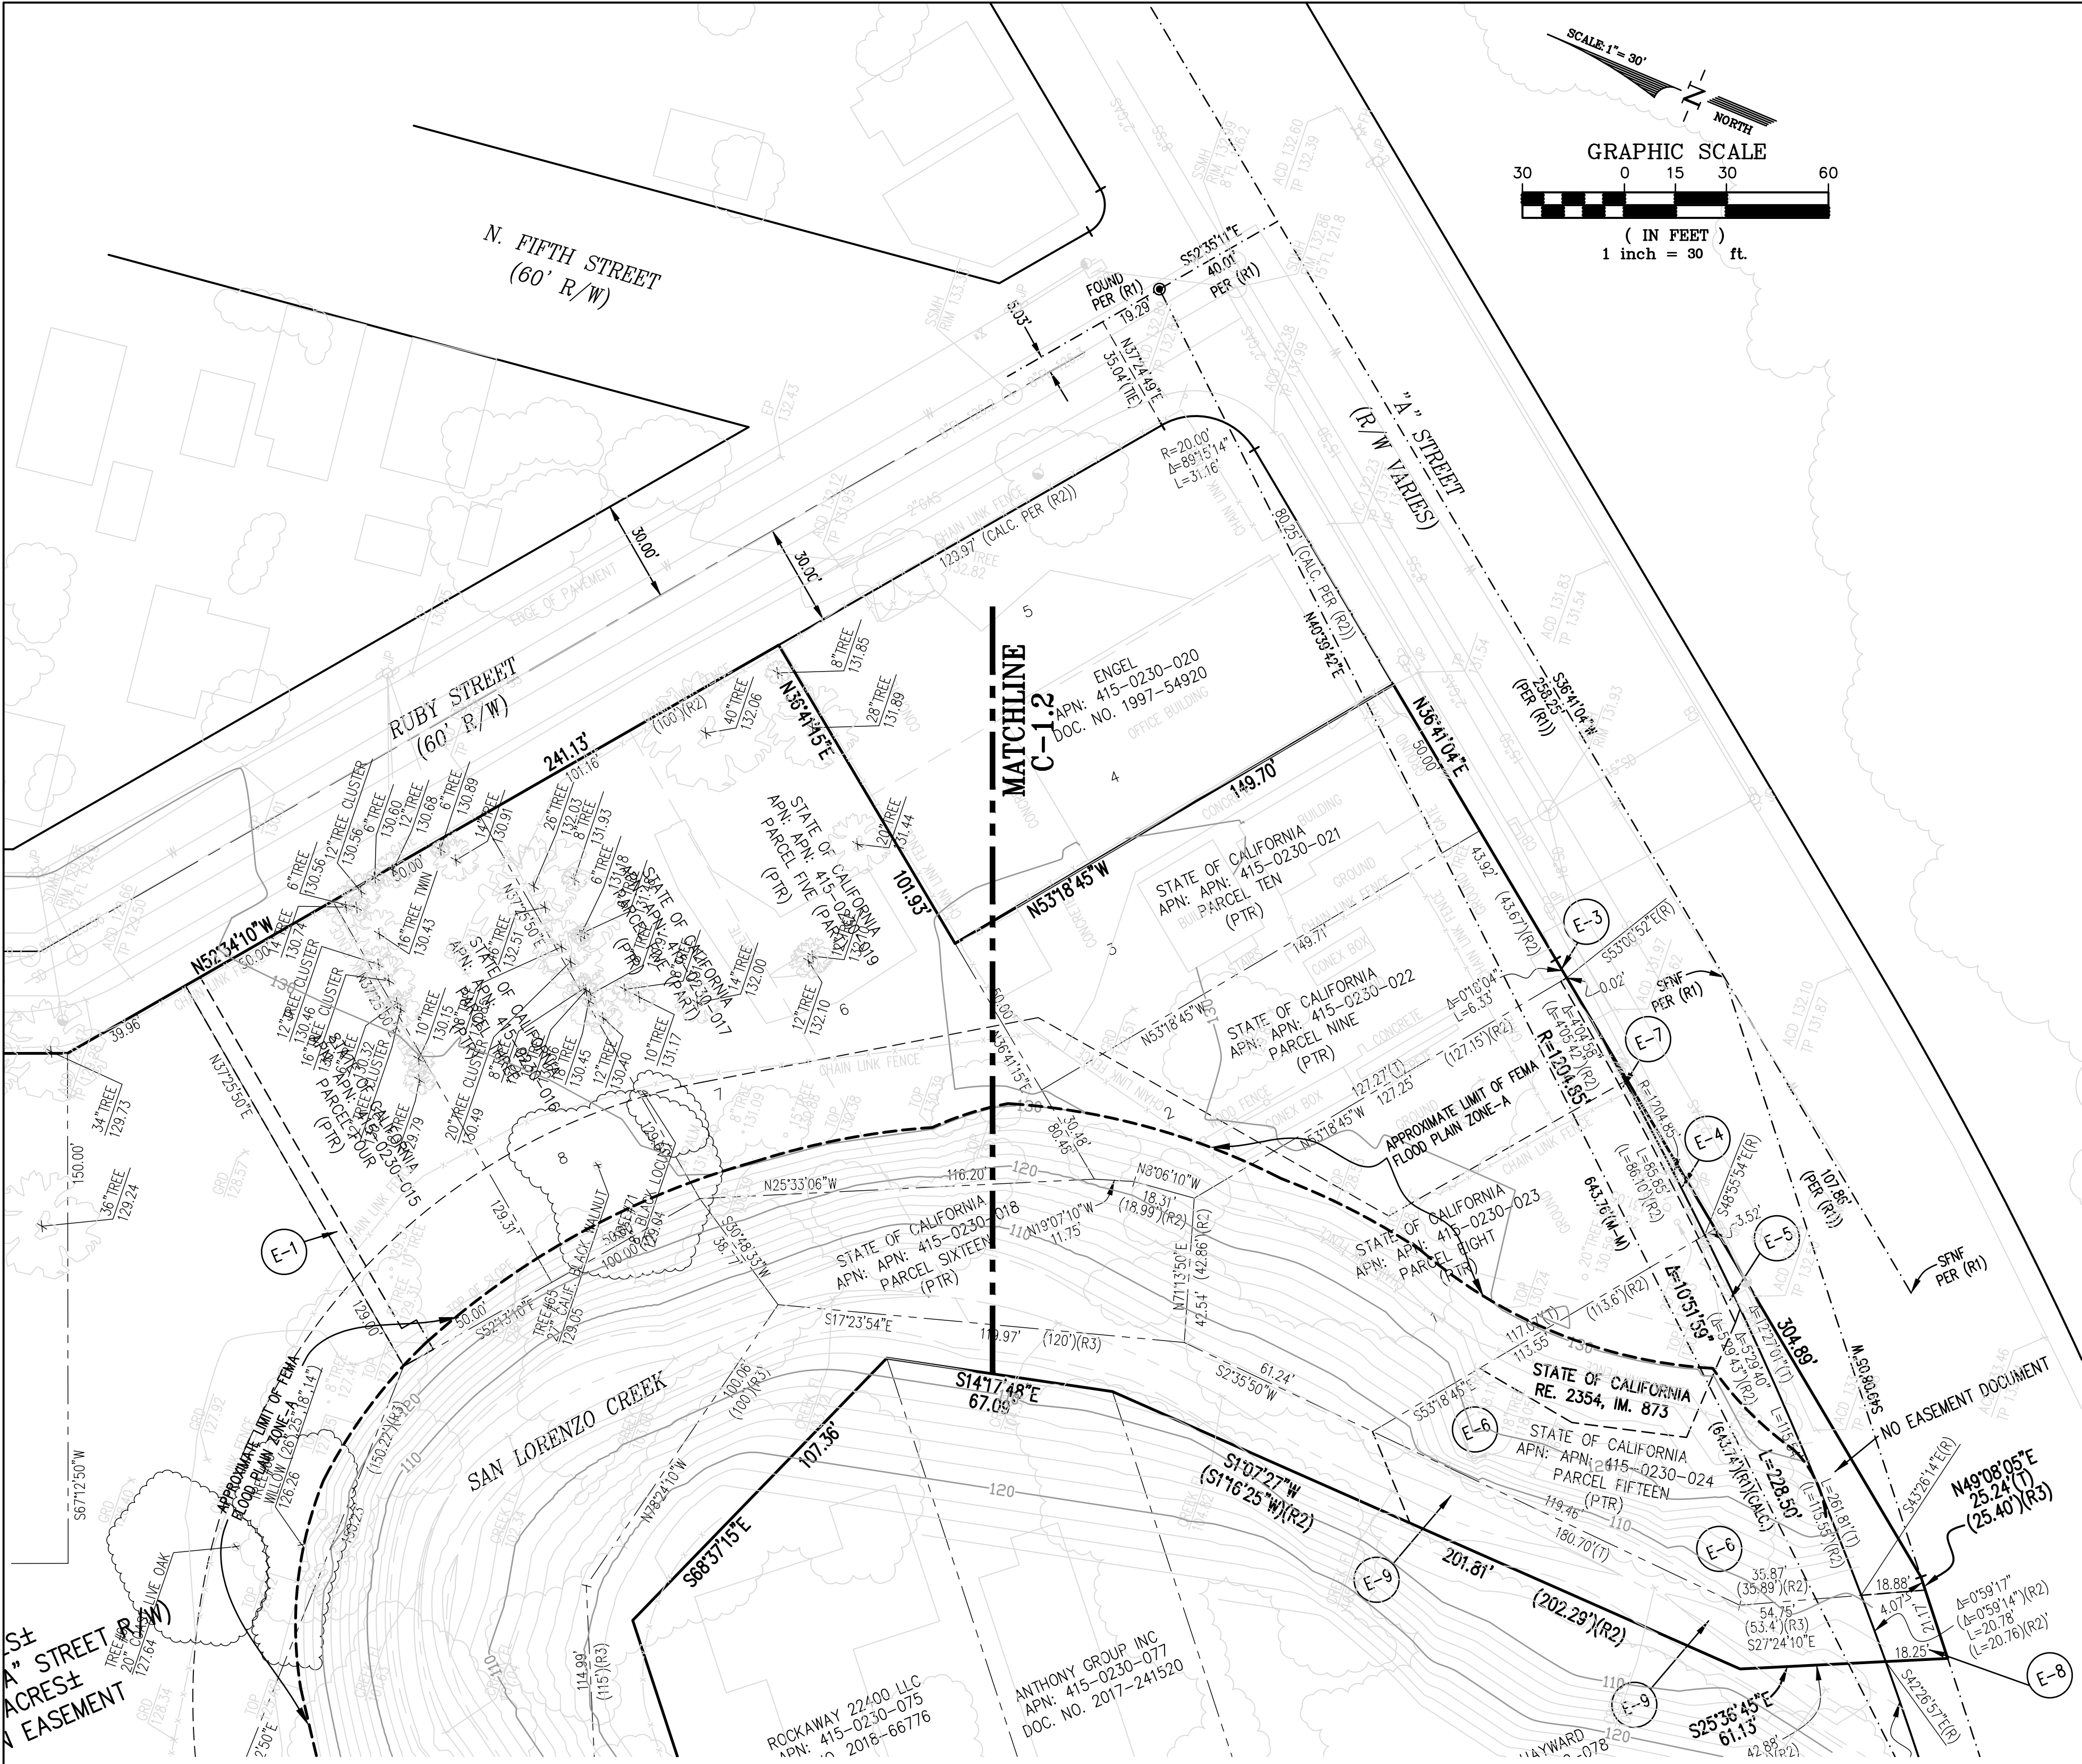

LEGEND	
SYMBOLS	DESCRIPTION
---	BOUNDARY — SUBJECT PROPERTY
---	RIGHT-OF-WAY LINE
---	INTERIOR LOT LINE
---	EASEMENT LINE
---	OLD LOT LINE
---	MONUMENT LINE
---	CENTERLINE
---	TIE LINE
●	FOUND STREET MONUMENT AS NOTED
SNF	SEARCH FOR AND NOT FOUND
S.F.	SQUARE FEET
±	MORE OR LESS
(R1)	REFERENCE
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(202.29')(R2)	RECORD DATA PER (R2)
(M-ML)	CONVERTED TO GROUND DISTANCE
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---	EASEMENT NOTE
---	BUILDING LINE
---	TOP/TOE
---	ELECTROLIER
---	FOUND STANDARD CITY MONUMENT
---	FIRE HYDRANT
---	CATCH BASIN
---	AREA DRAIN
---	WATER VALVE
---	WATER METER
---	STORM DRAIN MANHOLE
---	SANITARY SEWER CLEANOUT
---	SANITARY SEWER MANHOLE
---	TELEPHONE MANHOLE
---	PACIFIC GAS AND ELECTRIC MANHOLE
---	TREE
---	ASPHALT CONCRETE
---	FINISH FLOOR
---	JOINT POLE
---	TRAFFIC SIGNAL
---	TRAFFIC SIGNAL BOX
---	STREET LIGHT
---	STREET LIGHT BOX
---	PACIFIC GAS AND ELECTRIC BOX
---	POWER POLE
---	TELEVISION CABLE BOX
---	CONCRETE
---	UTILITY BOX
---	ROOF DRAIN
---	4" BOLLARD
---	WATER BOX
---	PARKING METER
---	GAS VALVE
---	WOOD FENCE
---	CHAIN LINK FENCE
---	SIGN
---	CONCRETE ELEVATION
---	GROUND ELEVATION
---	TOP OF PAVEMENT ELEVATION
---	TOP OF CURB ELEVATION
---	BACK OF WALK ELEVATION
---	FLOW LINE ELEVATION

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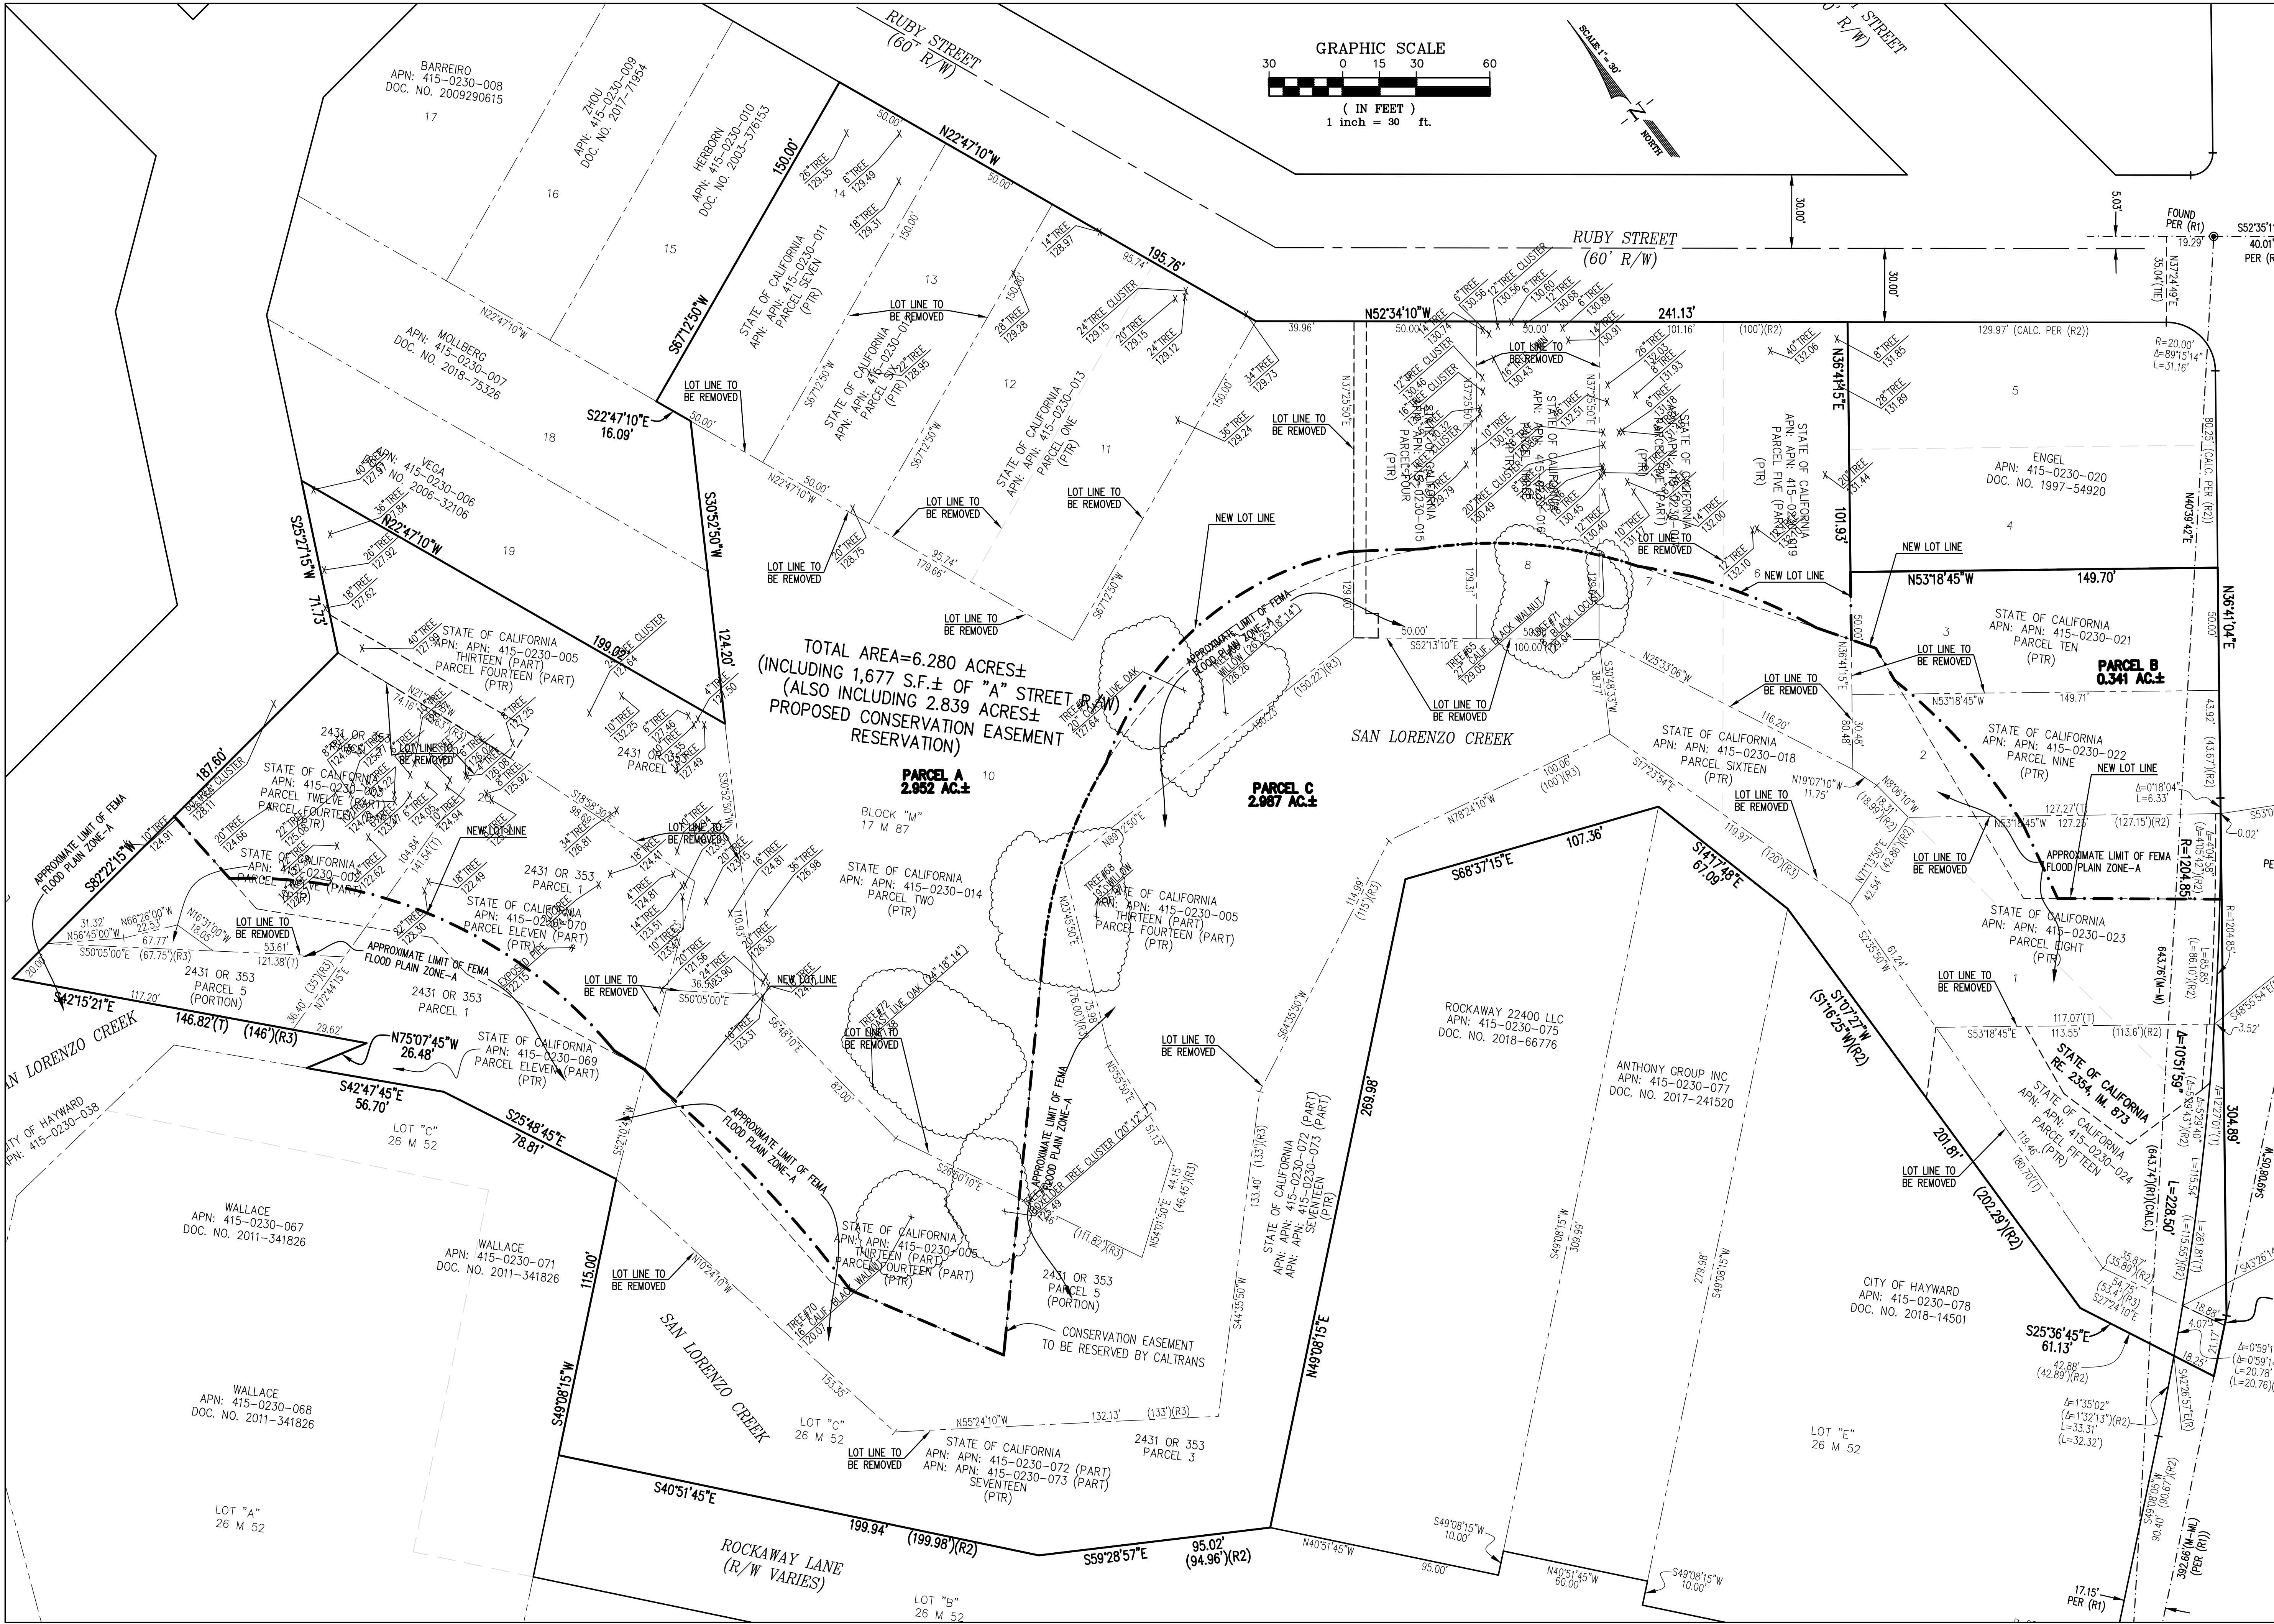
REVISION SCHEDULE	
No.	ISSUE

JOB NUMBER:	10004410
DRAWN BY:	CW
CHECKED BY:	
DATE:	JANUARY 2019
SCALE:	1" = 30'

TITLE: **TOPOGRAPHIC & BOUNDARY SURVEY**

SHEET:
C-1.2

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No.	ISSUE

JOB NUMBER:	10004410
DRAWN BY:	CW
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DATE:	JANUARY 2019
SCALE:	1" = 30'

TITLE: **PROPOSED BOUNDARY (LOT LINE ADJUSTMENT)**

SHEET:

C-1.3

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REVISION SCHEDULE

No.	ISSUE	DATE

JOB NUMBER: 10004A10

DRAWN BY: CW

CHECKED BY: J

DATE: JANUARY 2019

SCALE: 1" = 30'

TITLE: LOT LINE
ADJUSTMENT


SHEET:

C-1.4

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NEW LOT LINE DETAILS

SCALE: 1"=100'

LINE TABLE		
LINE	LENGTH	BEARING
L1	187.60'	S82°22'15"W
L2	71.73'	S25°27'15"W
L3	199.02'	N22°47'10"W
L4	124.20'	S30°52'50"W
L5	16.09'	S22°47'10"E
L6	150.00'	S67°12'50"W
L7	195.76'	N22°47'10"W
L8	241.13'	N52°34'10"W
L9	101.93'	N36°41'15"E
L10	149.70'	N53°18'45"W
L11	304.89'	N36°41'04"E
L12	61.13'	N25°36'45"W
L13	201.81'	N01°07'27"E
L14	67.09'	N14°17'48"W
L15	107.36'	N68°37'15"W
L16	269.98'	S49°08'15"W
L17	95.02'	N59°28'57"W
L18	199.94'	N40°51'45"W
L19	115.00'	N49°08'15"E
L20	78.81'	N25°48'45"W
L21	56.70'	N42°47'45"W
L22	26.48'	S75°07'45"E
L23	146.82'	N42°15'21"W
L24	33.94'	S04°20'26"E
L25	14.62'	S20°41'25"E
L26	10.63'	S03°53'14"E
L27	67.85'	S29°40'37"E
L28	164.93'	N42°59'28"E
L29	29.58'	S54°39'52"E
L30	25.58'	S33°35'56"E
L31	15.23'	S06°46'58"W
L32	32.89'	S12°22'50"W
L33	66.83'	S52°25'36"E
L34	27.64'	S36°41'15"W
L35	129.57'	N36°41'15"E
L36	15.01'	S33°35'56"E
L37	10.57'	S33°35'56"E
L38	25.24'	S49°08'05"W

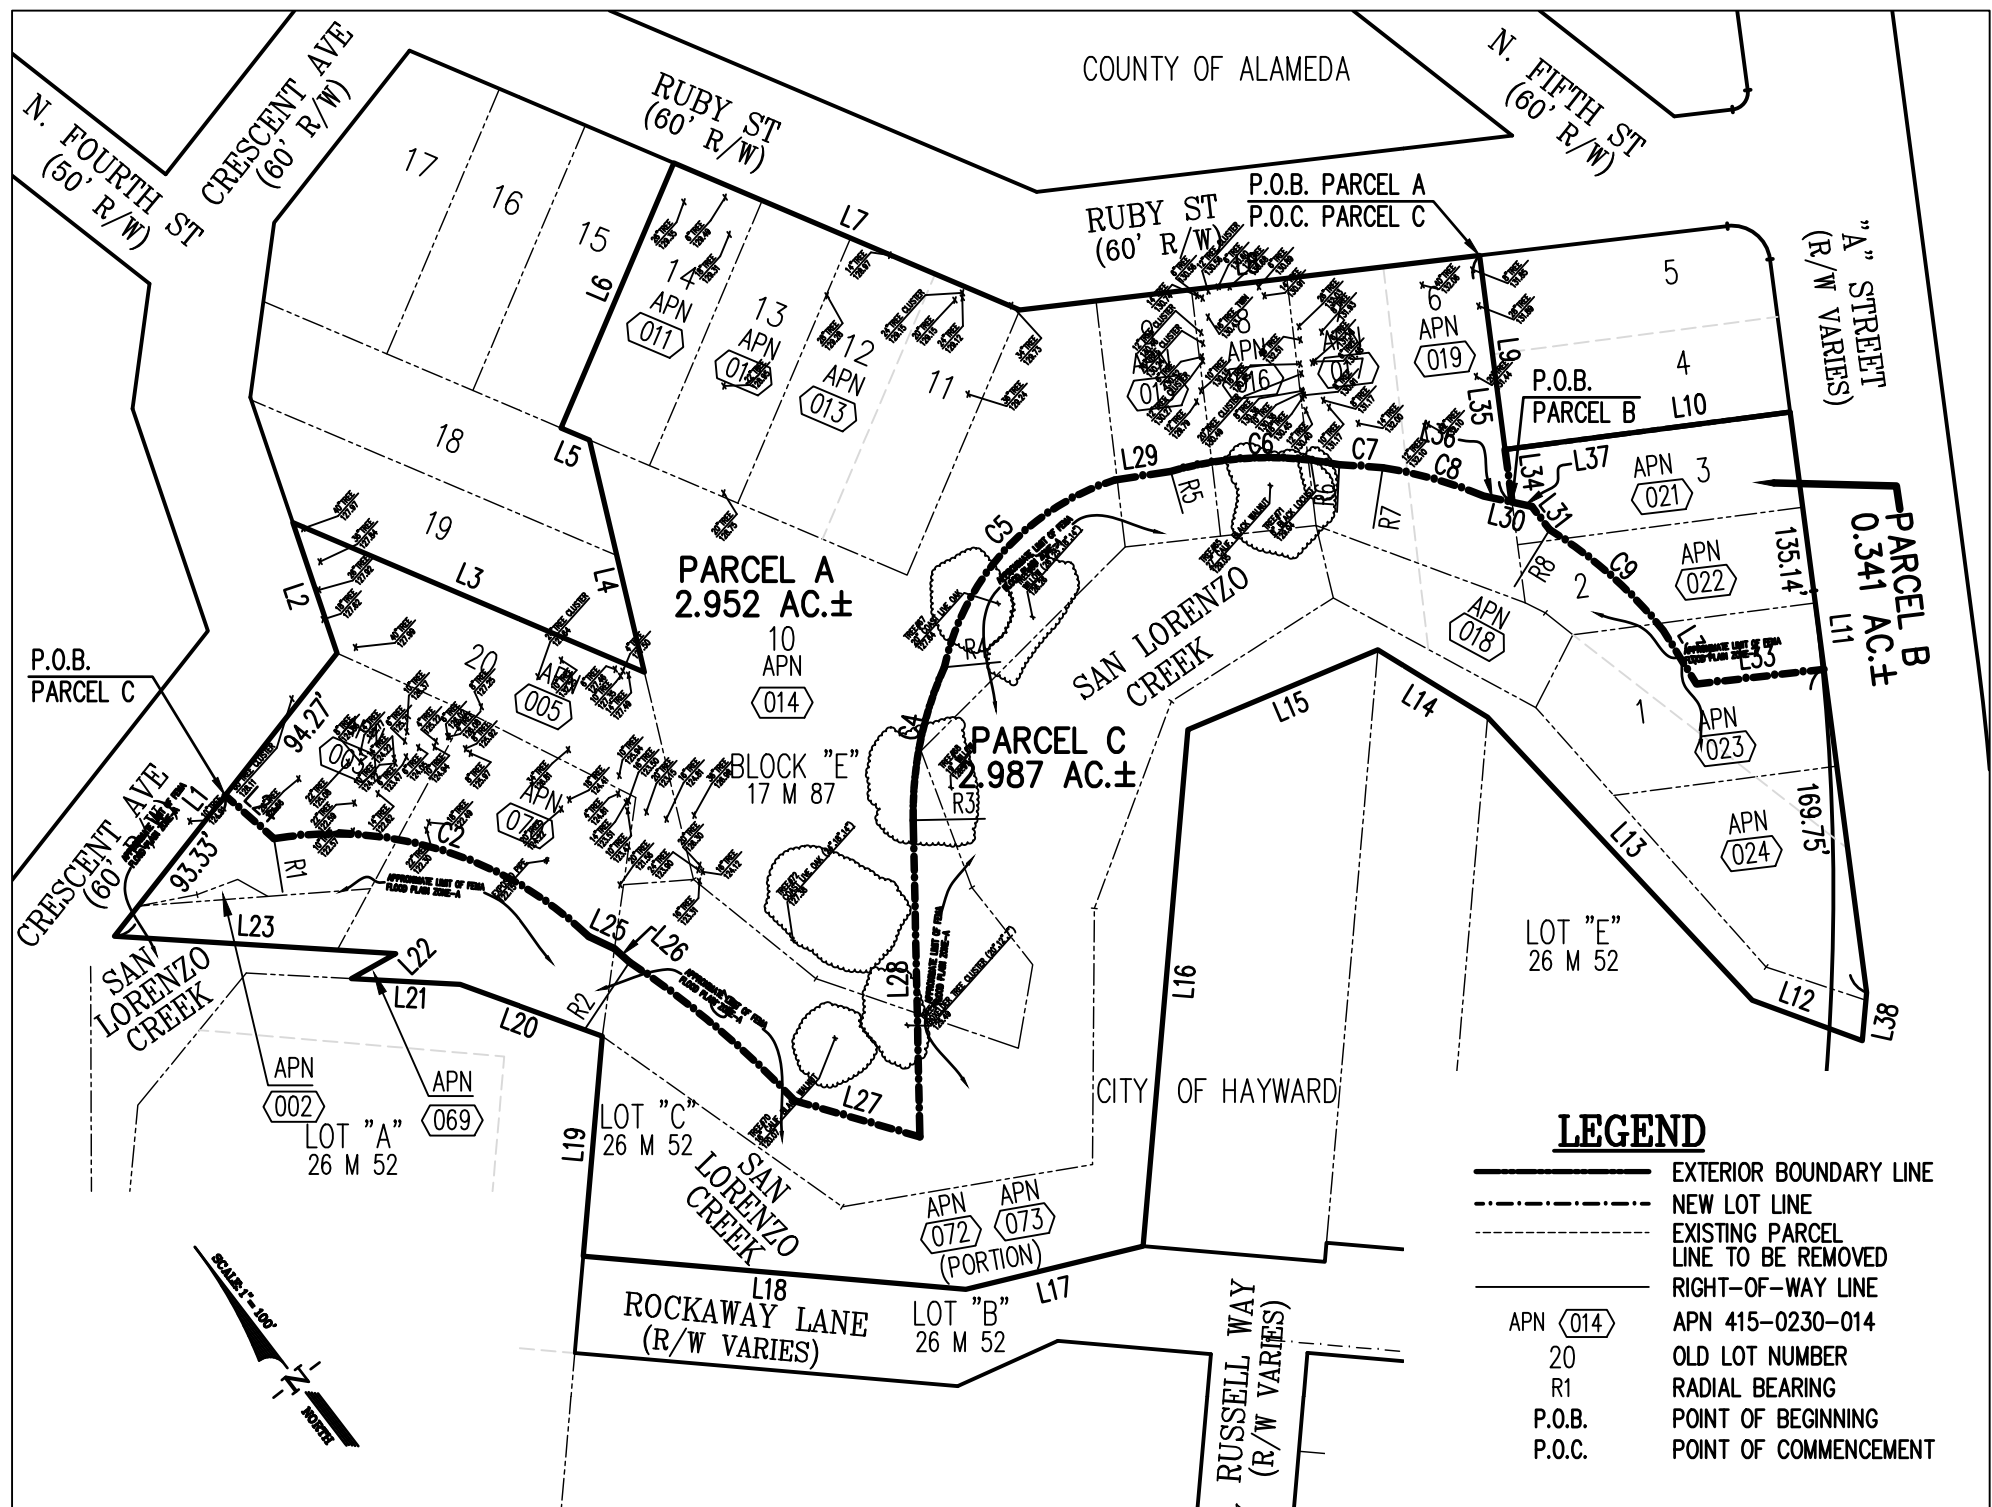CURVE TABLE			
CURVE	LENGTH	RADIUS	DELTA
C1	228.50'	1204.85'	10°51'59"
C2	178.02'	193.08'	52°49'37"
C3	112.52'	504.77'	12°46'18"
C4	82.04'	185.00'	25°24'33"
C5	137.96'	131.52'	60°06'11"
C6	88.60'	185.00'	27°26'26"
C7	22.78'	508.83'	02°33'56"
C8	54.81'	233.26'	13°27'47"
C9	79.44'	233.26'	19°30'51"

RADIAL BEARING	
R1	N35°03'37"E(R)
R2	N77°47'36"E(R)
R3	N47°00'32"W(R)
R4	N33°34'36"W(R)
R5	N28°13'42"E(R)
R6	N46°53'44"E(R)
R7	N53°04'14"E(R)
R8	N75°59'40"E(R)

NEW LOT LINE DIMENSIONS



EARTHWORK:

ANALYSIS PERFORMED:
DATE: 01/07/2019

EARTHWORK QUANTITIES:

GROSS CUT = 2,070 CY
GROSS FILL = 3,490 CY
NET (FILL) = 1,420 CY

- CONTRACTOR SHALL BE RESPONSIBLE FOR PERFORMING INDEPENDENT QUANTITY ANALYSIS PRIOR TO BIDDING.
- ANALYSIS DOES NOT ACCOUNT FOR TRENCH SPOILS, FOOTINGS, SOIL-MITIGATION, OVER-EXCAVATION WORK, OR EXPANSION/CONTRACTION FACTORS.
- FOUNDATION AND PAVEMENTS SECTIONS ASSUMED TO BE 12" THICK.

LEGEND

SYMBOLS

SYMBOLS	DESCRIPTION
---	INTERIOR PROPERTY BOUNDARY LINE
---	EXTERIOR PROPERTY BOUNDARY LINE
---	ADJOINERS PROPERTY LINE
---	STREET CENTERLINE
---	EASEMENT LINE
---	GRADE BREAK LINE
---	DAYLIGHT LIMIT (LIMIT OF WORK)
---	CONSERVATION EASEMENT
---	CONSERVATION EASEMENT
---	CREEK SETBACK DETERMINATION
---	FEMA FLOOD PLAIN LIMIT
---	EDGE OF CREEK TOE
---	CREEK FLOWLINE
---	CENTER OF CREEK FLOWLINE

☆	FH	ELECTROLIER
■	CB	FIRE HYDRANT
○	AD	CATCH BASIN
○	WV	AREA DRAIN
□	WM	WATER VALVE
○	SDMH	WATER METER
○	SSCO	STORM DRAIN MANHOLE
○	SSMH	SANITARY SEWER CLEANOUT
○	GV	SANITARY SEWER MANHOLE
○	RD	GAS VALVE
○	JP	SIGN
○	FF	ROOF DRAIN
○	CONC	JOINT POLE
×	4.85	FENCE
×	GRD	FINISH FLOOR
×	6.13	CONCRETE
×	TP	FINISH GRADE ELEVATION
×	9.18	GROUND ELEVATION
×	TC	TOP OF PAVEMENT ELEV.
×	10.82	TOP OF CURB ELEVATION
×	BSW	BACK OF SIDEWALK ELEVATION
×	10.82	FLOW LINE ELEVATION
×	FL	WATER LINE
×	10.31	STORM DRAIN LINE
---	6"W	SANITARY SEWER LINE
---	12"SD	JOINT UTILITY TRENCH
---	8"SS	
---	JT	

SECTIONS:

- SEE SHEET C-4.1.3 FOR:
 - SITE SECTIONS
 - CREEK-SETBACK-DETERMINATION TYPICAL SECTION(S).

NOTES:

- SEE COUNTY GRADING NOTES ON SHEET C-4.1.2
- SEE BENCHMARK AND BEARING INFORMATION ON SHEET C-4.1.2

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REVISION SCHEDULE

No.	ISSUE	DATE

JOB NUMBER:	10004A10
DRAWN BY:	CW
CHECKED BY:	JL
DATE:	JULY 9, 2019
SCALE:	1" = 30'
TITLE:	PRELIMINARY GRADING PLAN: ELEVATIONS

SHEET:

C-4.1.1

PRELIMINARY - Not for Construction -

Plot Date: 01/17/2020



COUNTY GRADING NOTES:

1. NO GRADING SHALL BE PERMITTED UNTIL A GRADING PLAN AND EROSION AND SEDIMENTATION CONTROL PLANS HAVE BEEN REVIEWED AND APPROVED BY THE COUNTY AND A GRADING PERMIT OR EXEMPTION IS OBTAINED FROM THE COUNTY OF ALAMEDA PUBLIC WORKS AGENCY IN ACCORDANCE WITH PROVISIONS OF THE ALAMEDA COUNTY GRADING ORDINANCE.
2. NO GRADING WORK SHALL BE ALLOWED DURING THE RAINY SEASON, FROM OCTOBER 1 TO APRIL 30 EXCEPT UPON A CLEAR DEMONSTRATION, TO THE SATISFACTION OF THE DIRECTOR OF PUBLIC WORKS, THAT AT NO STAGE OF THE WORK WILL THERE BE ANY SUBSTANTIAL RISK OF INCREASED SEDIMENT DISCHARGE FROM THE SITE.
3. PRIOR TO ANY WORK WITHIN A WATERCOURSE SETBACK, A WATERCOURSE ENCROACHMENT PERMIT OR A GRADING PERMIT SHALL BE SECURED FROM THE COUNTY OF ALAMEDA PUBLIC WORKS AGENCY IN ACCORDANCE WITH PROVISIONS OF THE ALAMEDA COUNTY WATERCOURSE ORDINANCE. THE WATERCOURSE ORDINANCE ESTABLISHED A SETBACK OF 20 FEET FROM THE TOP OF BANK. HOWEVER, FOR EXISTING BANK SLOPES AT 2:1 OR STEEPER, ESTABLISH THE SETBACK BY DRAWING A LINE AT 2:1 FROM THE TOE OF THE EXISTING BANK TO A POINT WHERE IT INTERCEPTS THE GROUND SURFACE AND THEN ADDING 20 FEET. A SITE GRADING PLAN SHALL DELINEATE THIS WATERCOURSE SETBACK ACCORDINGLY.
4. PRIOR TO ANY GRADING WORK NEAR/WITHIN THE WATERCOURSE OR NEAR/WITHIN ANY POTENTIAL RIPARIAN HABITATS FOR THE STATE AND FEDERAL PROTECTED SPECIES, THE OWNER/DEVELOPER SHALL SECURE THE NECESSARY PERMITS OR APPROVALS REQUIRED FROM OTHER REGULATORY STATE AND FEDERAL AGENCIES AS REQUIRED.
5. SITES WITH LAND DISTURBANCES GREATER THAN (1) ONE ACRE MUST FILE A NOTICE OF INTENT (NOI) WITH THE STATE WATER RESOURCES CONTROL BOARD FOR COVERAGE UNDER THE STATE GENERAL NPDES PERMIT FOR CONSTRUCTION ACTIVITIES. A COPY OF THE NOI MUST BE SUBMITTED TO THE DISTRICT PRIOR TO ISSUANCE OF A GRADING PERMIT FOR THE SITE OR ANY LAND DISTURBANCE ON THE SITE. A STORM WATER POLLUTION PREVENTION PLAN (SWPPP) SHALL BE MADE AVAILABLE TO THE DISTRICT PRIOR TO ISSUANCE OF GRADING PERMIT OR ANY LAND DISTURBANCE ON THE SITE.

BASIS OF BEARINGS

THE BASIS OF BEARINGS OF THIS SURVEY IS BASED ON FOUND STREET MONUMENTS ALONG "A" STREET BETWEEN ROCKAWAY LANE AND RUBY STREET AS SHOWN ON THAT CERTAIN RECORD OF SURVEY, FILED AUGUST 7, 1973, IN BOOK 9 OF RECORDS OF SURVEY, AT PAGES 30-31, IN THE OFFICE OF THE COUNTY RECORDER OF ALAMEDA COUNTY, STATE OF CALIFORNIA. THE BEARING IS TAKEN AS NORTH 40°51'45" WEST PER CALIFORNIA DEPARTMENT OF TRANSPORTATION RIGHT OF WAY RECORD MAP R-167.3.

BENCHMARK

ELEVATIONS ARE BASED ON THE NORTH AMERICAN VERTICAL DATUM OF 1988 (NAVD 88).

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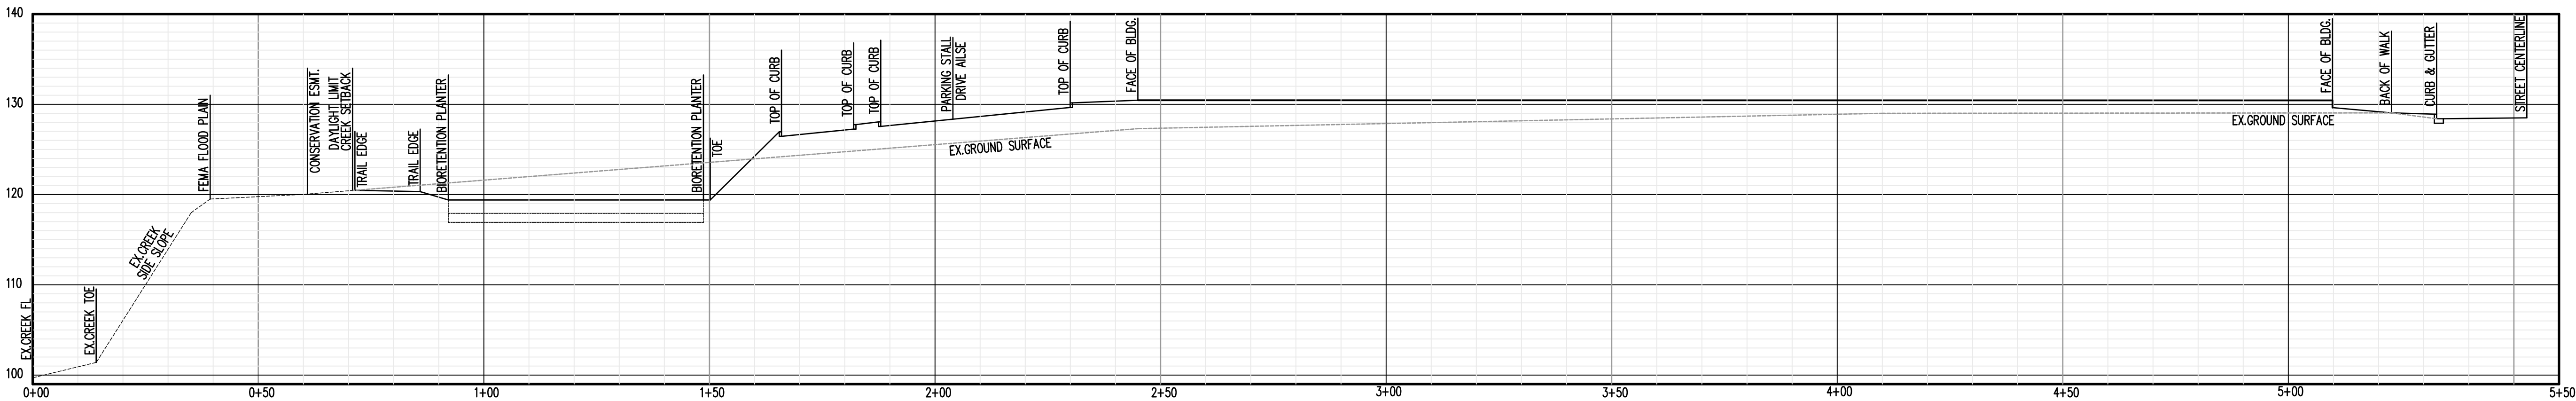
REVISION SCHEDULE	
No.	ISSUE

JOB NUMBER:	10004410
DRAWN BY:	CW
CHECKED BY:	JL
DATE:	JULY 9, 2019
SCALE:	1" = 30'
TITLE:	PRELIMINARY GRADING PLAN: ELEVATIONS

SHEET:


C-4.1.2

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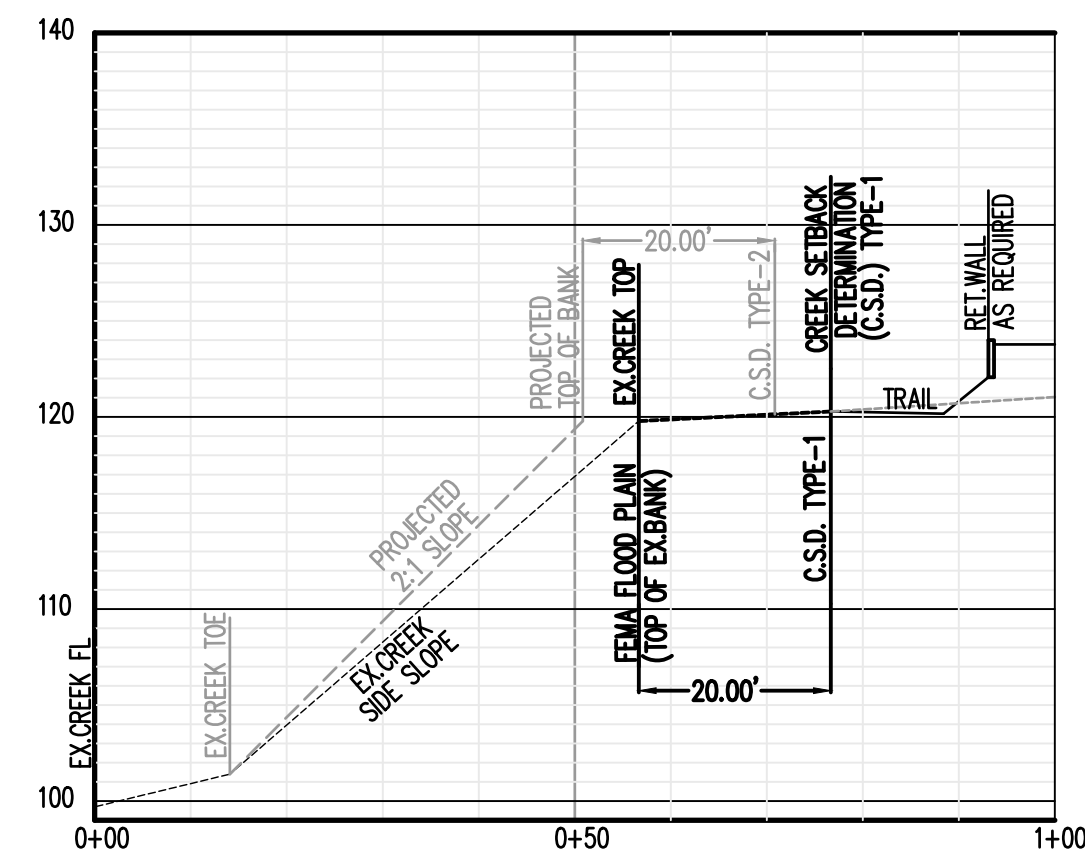
SECTION A-A

HORZ. 1"=20'
VERT. 1"=10'




SECTION B-B

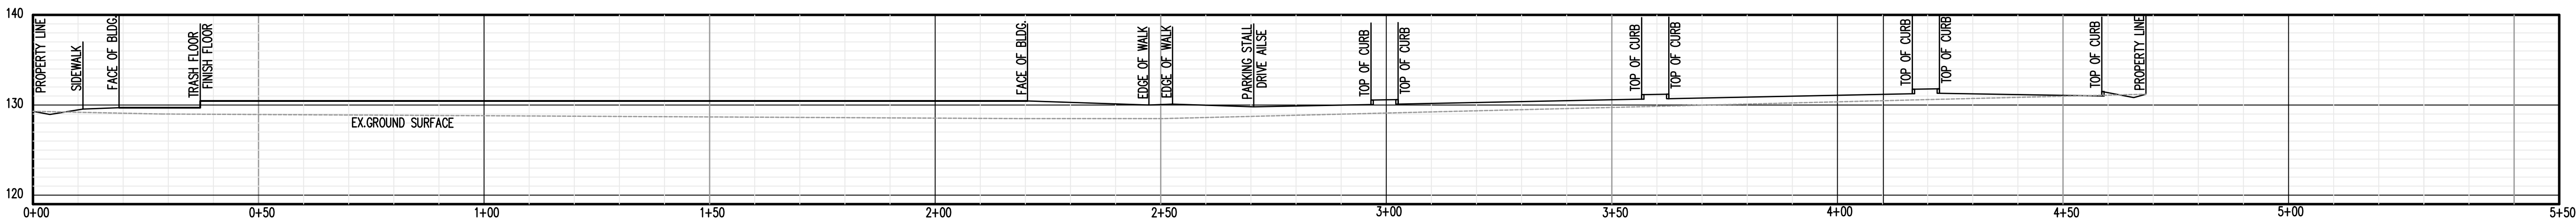HORZ. 1"=20'
VERT. 1"=10'



**CREEK SETBACK DETERMINATION
TYPE-1**

EXAMPLE: FLOOD PLAIN SETBACK
HORZ. 1"=20'
VERT. 1"=10'

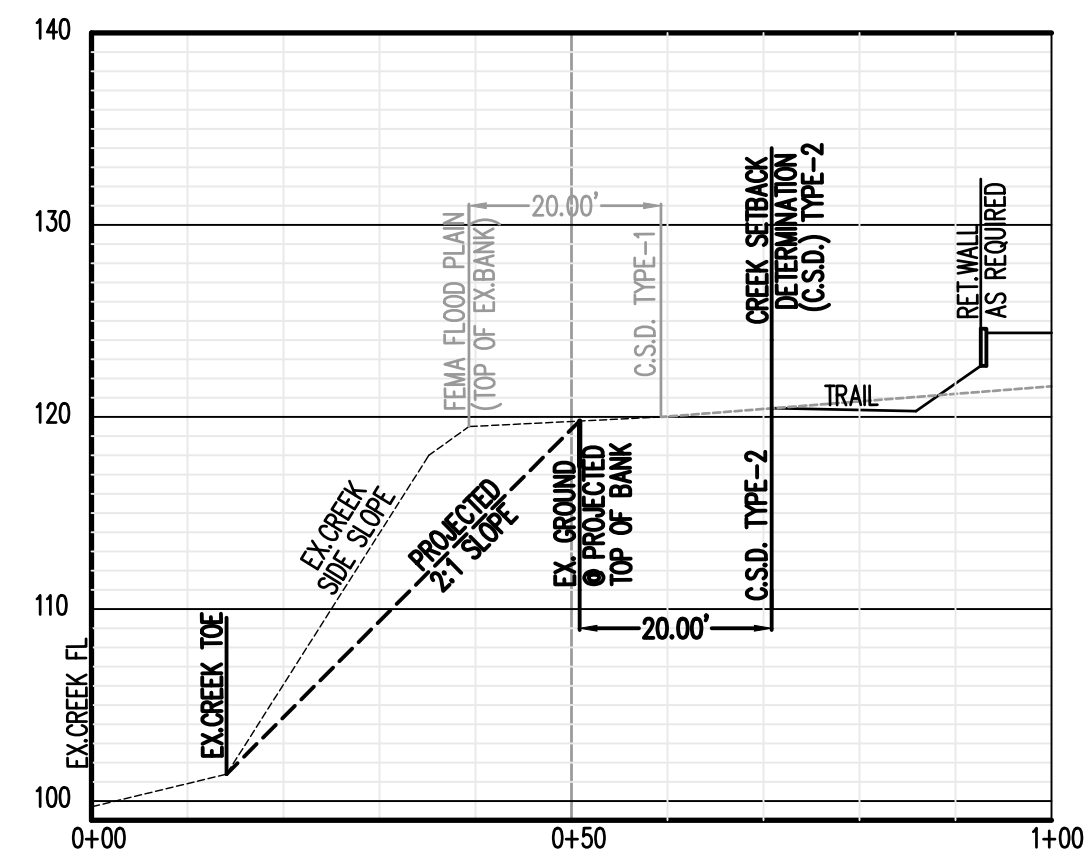

**CREEK SETBACK DETERMINATION
TYPE-2**

EXAMPLE: PROJECTED SLOPE SETBACK
HORZ. 1"=20'
VERT. 1"=10'

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No. | ISSUE | DATE

JOB NUMBER: 10004A10
DRAWN BY: CW
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SCALE: 1" = 30'
TITLE: PRELIMINARY
GRADING PLAN:
SECTIONS


SHEET:

C-4.1.3

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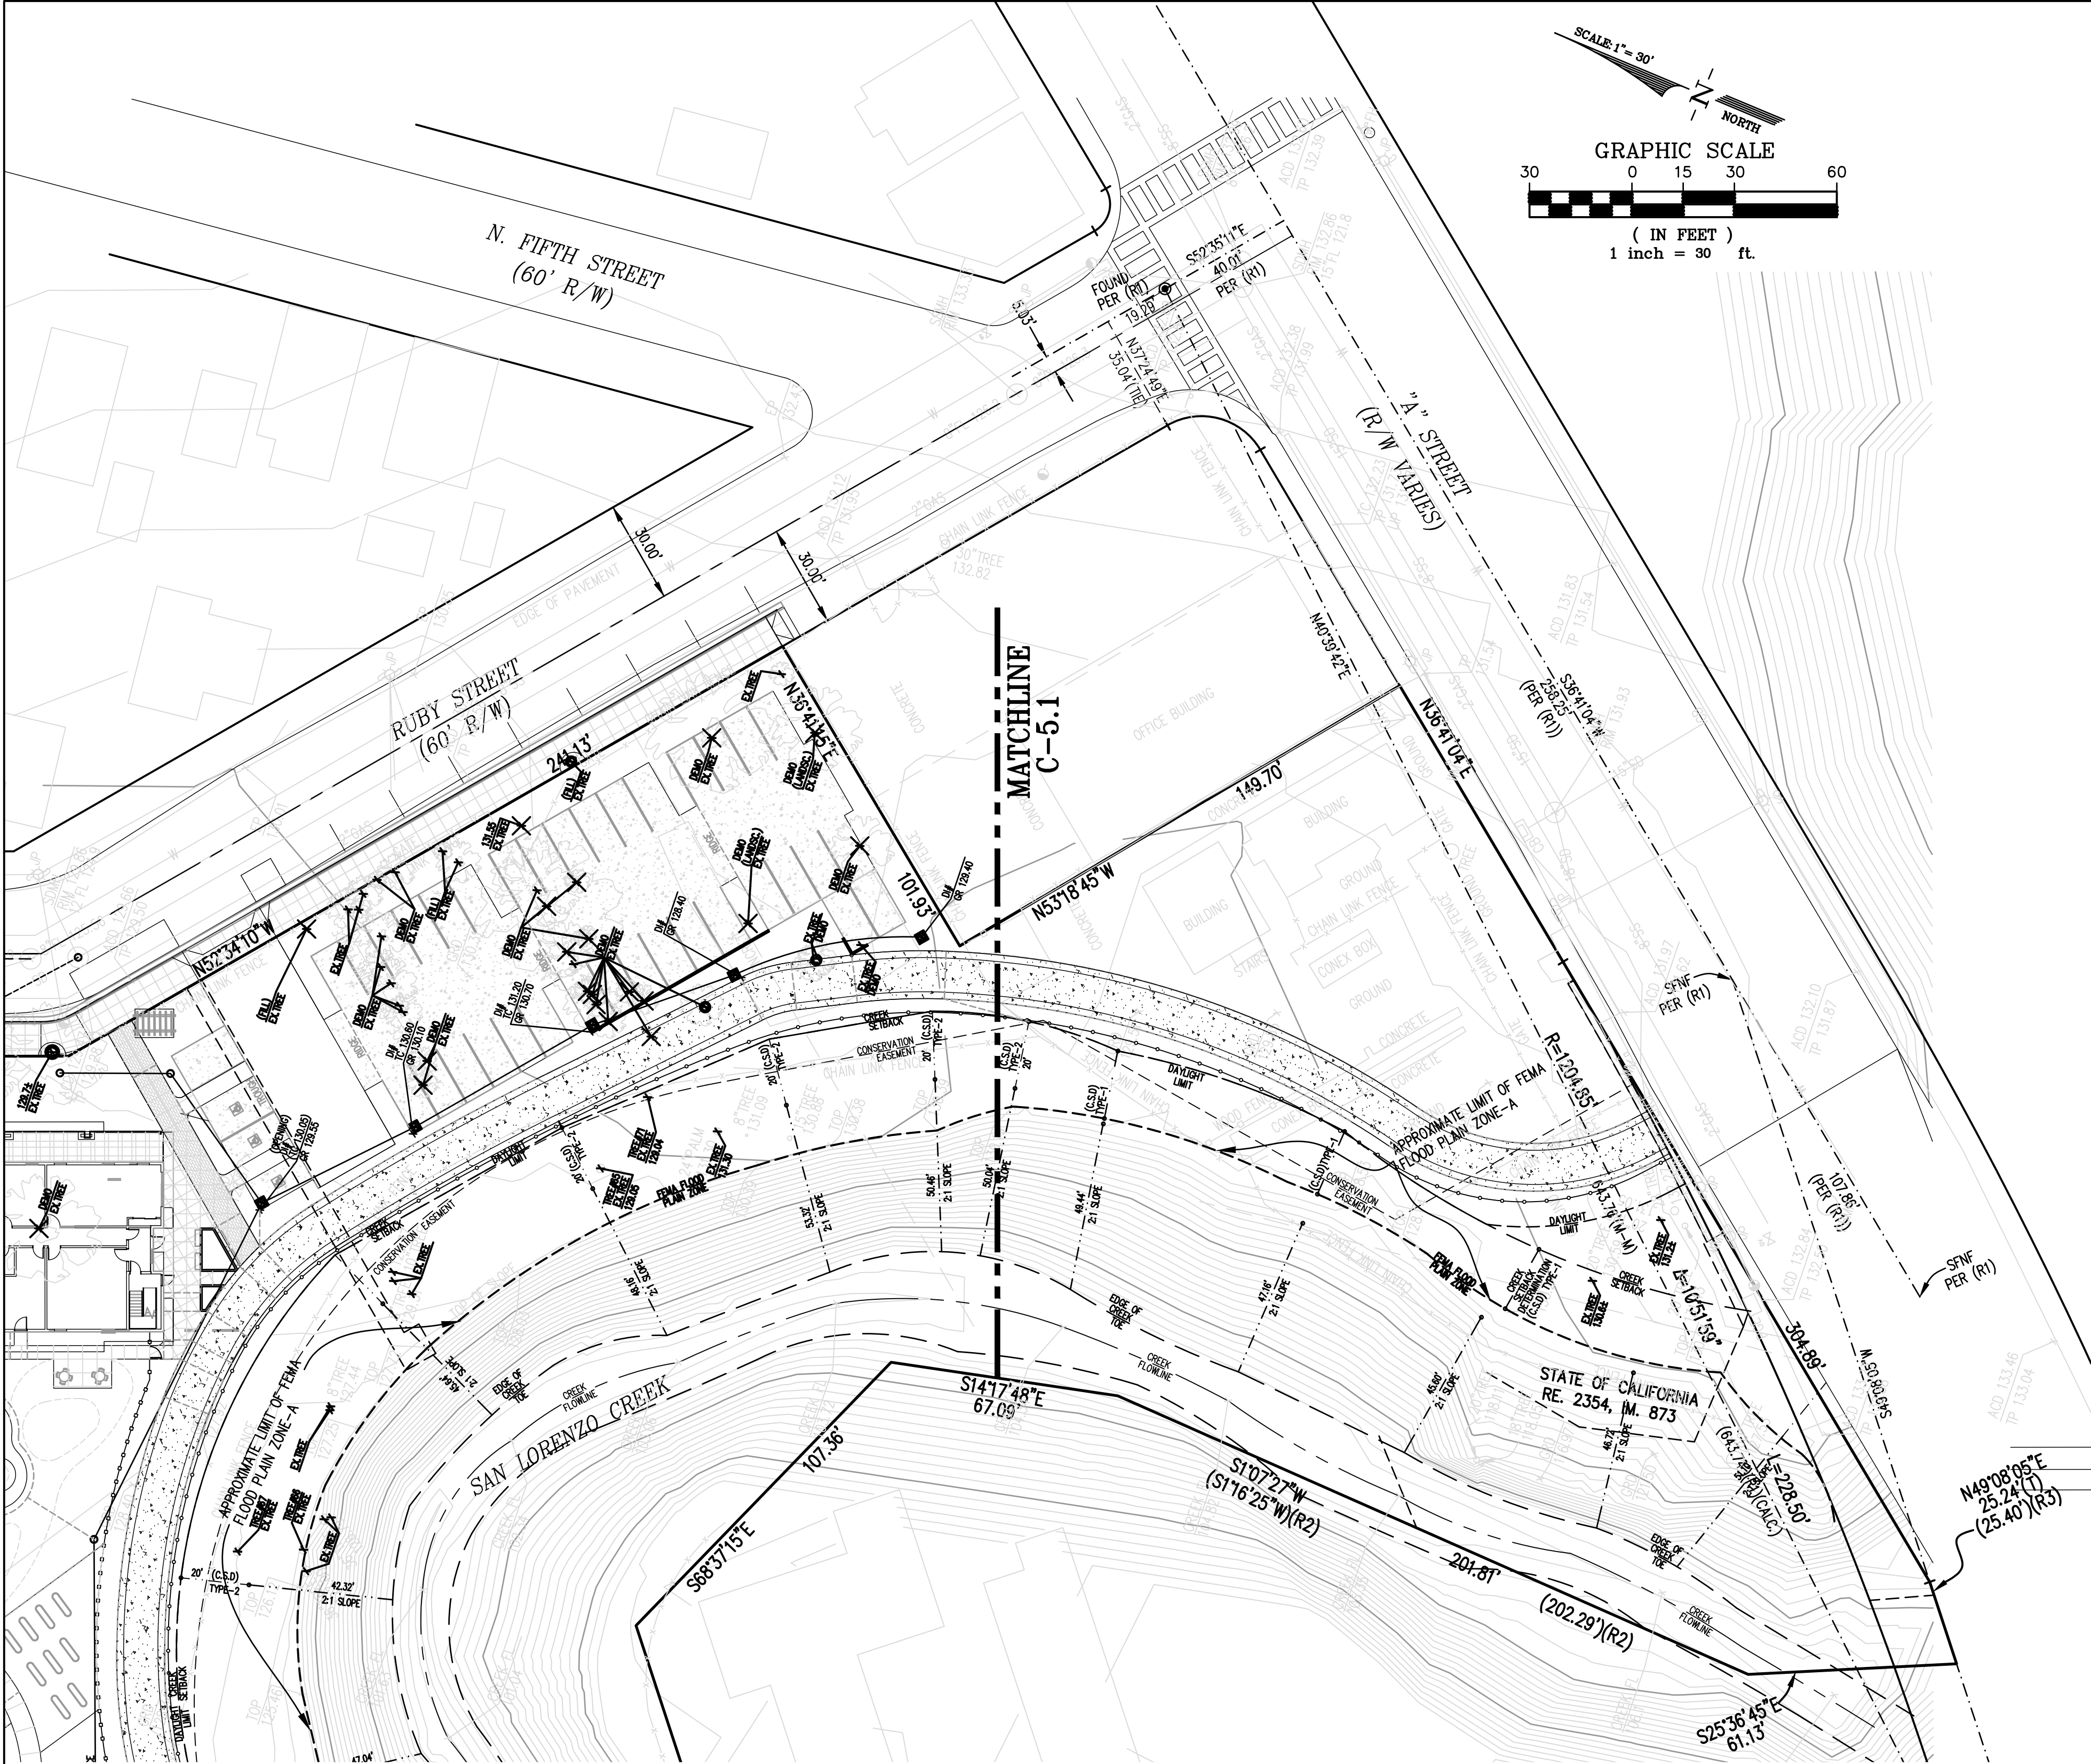
JOB NUMBER:	10004A10
DRAWN BY:	CW
CHECKED BY:	JL
DATE:	JULY 9, 2019
SCALE:	1" = 30'
TITLE:	PRELIMINARY UTILITY PLAN

SHEET:

C-5.1

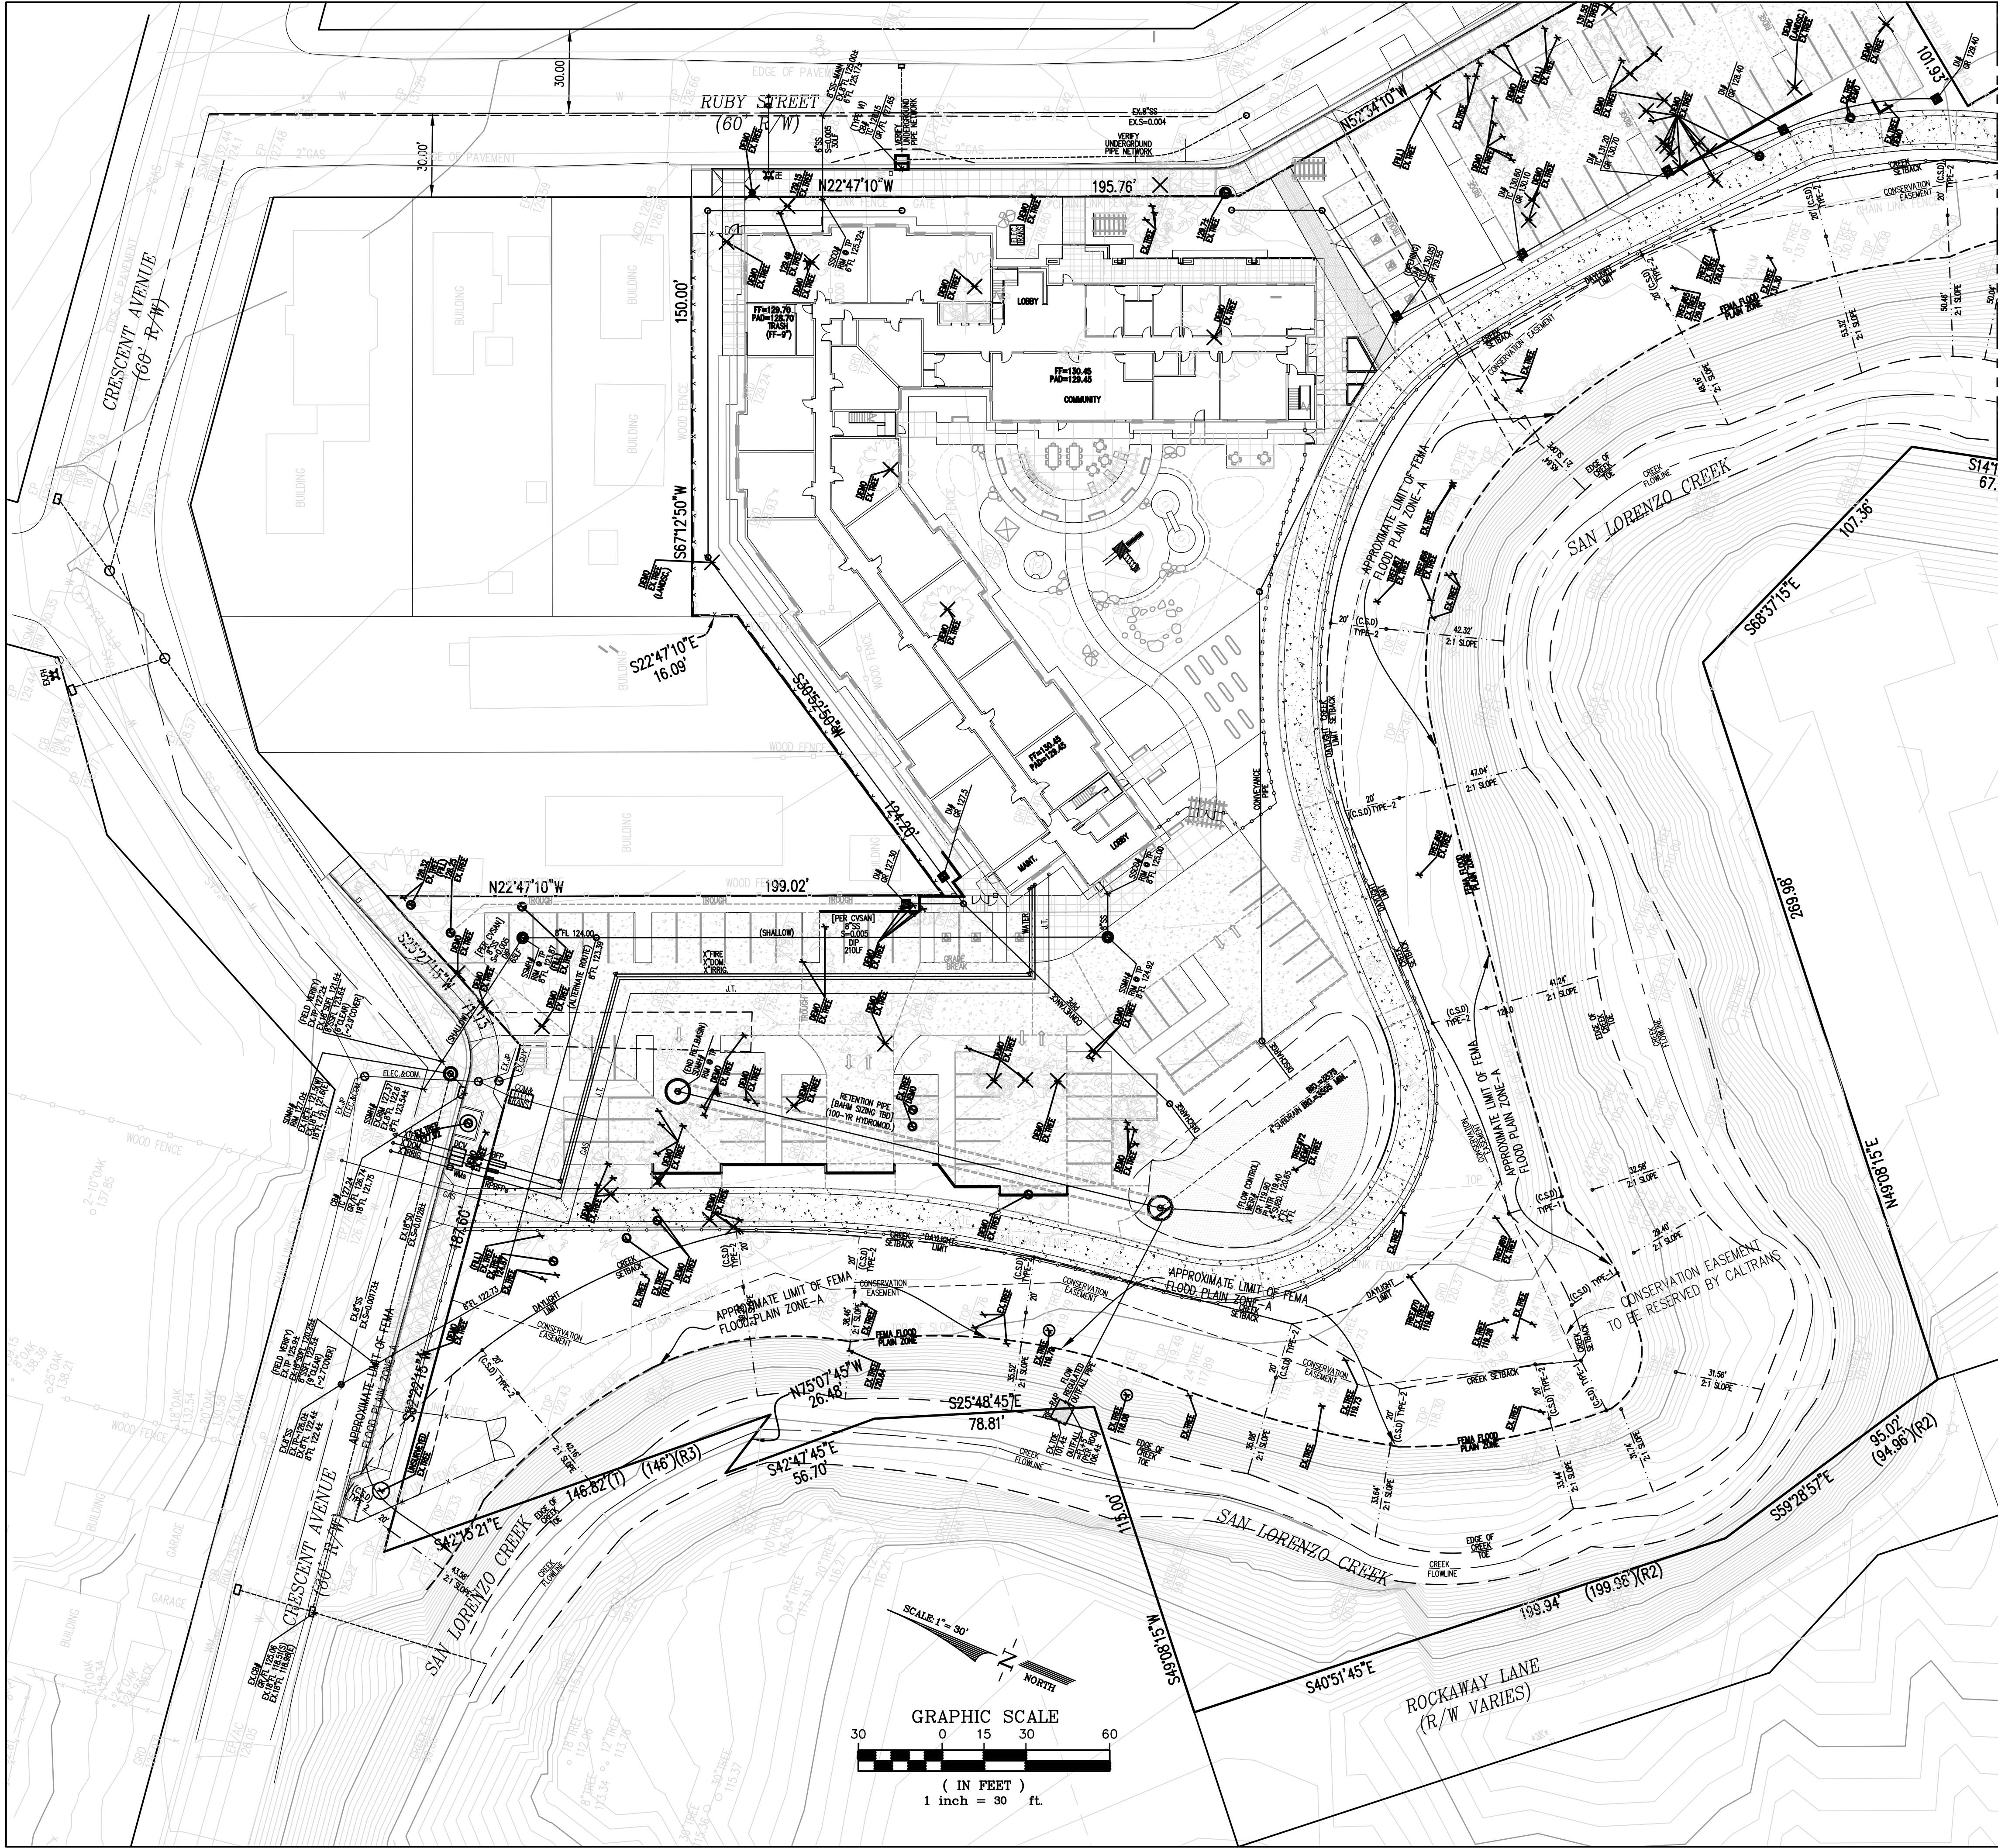PRELIMINARY - Not for Construction -

Plot Date: 01/17/2020



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SCALE:	1" = 30'
TITLE:	PRELIMINARY UTILITY PLAN


SHEET:

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STORM TREATMENT NOTES:

MAR=21"
SOILS CLASS D (CLAY) [ASSUMED]
PER ALAMEDA COUNTY CLEAN WATER PROGRAM PUBLICATION:
"STORMWATER C3 GUIDEBOOK" DATED OCTOBER 31, 2017 (VERSION 6).

- 1) HYDRO-MODIFICATION & STORM TREATMENT:
- A) THE PROJECT CREATES BETWEEN 10,000-SF AND 1-ACRE OF IMPERVIOUS SURFACE AREA FOR THE PROPOSED PRIVATE PROPERTY. THUS THE PROJECT WILL BE REQUIRED TO SUBMIT A STORMWATER CONTROL PLAN AND INCLUDE LID MEASURES.
- B) AS THE PROJECT PROPOSES MORE THAN 1-ACRE OF IMPERVIOUS SURFACES ON THE SITE AND IS LOCATED WITHIN AN "ATTACHMENT-A: HMP SUSCEPTIBILITY MAP" AREA. THUS, HYDROMODIFICATION (FLOW CONTROL) IS A REQUIREMENT PER THE GUIDEBOOK.

- 2) THE PROJECT SITE IS DELINEATED INTO THE MANAGEMENT AREAS SHOWN ON THE CHART ON THIS SHEET.
- 3) THE TREATMENT METHOD IS CHOSEN TO BE BIORETENTION FACILITY.

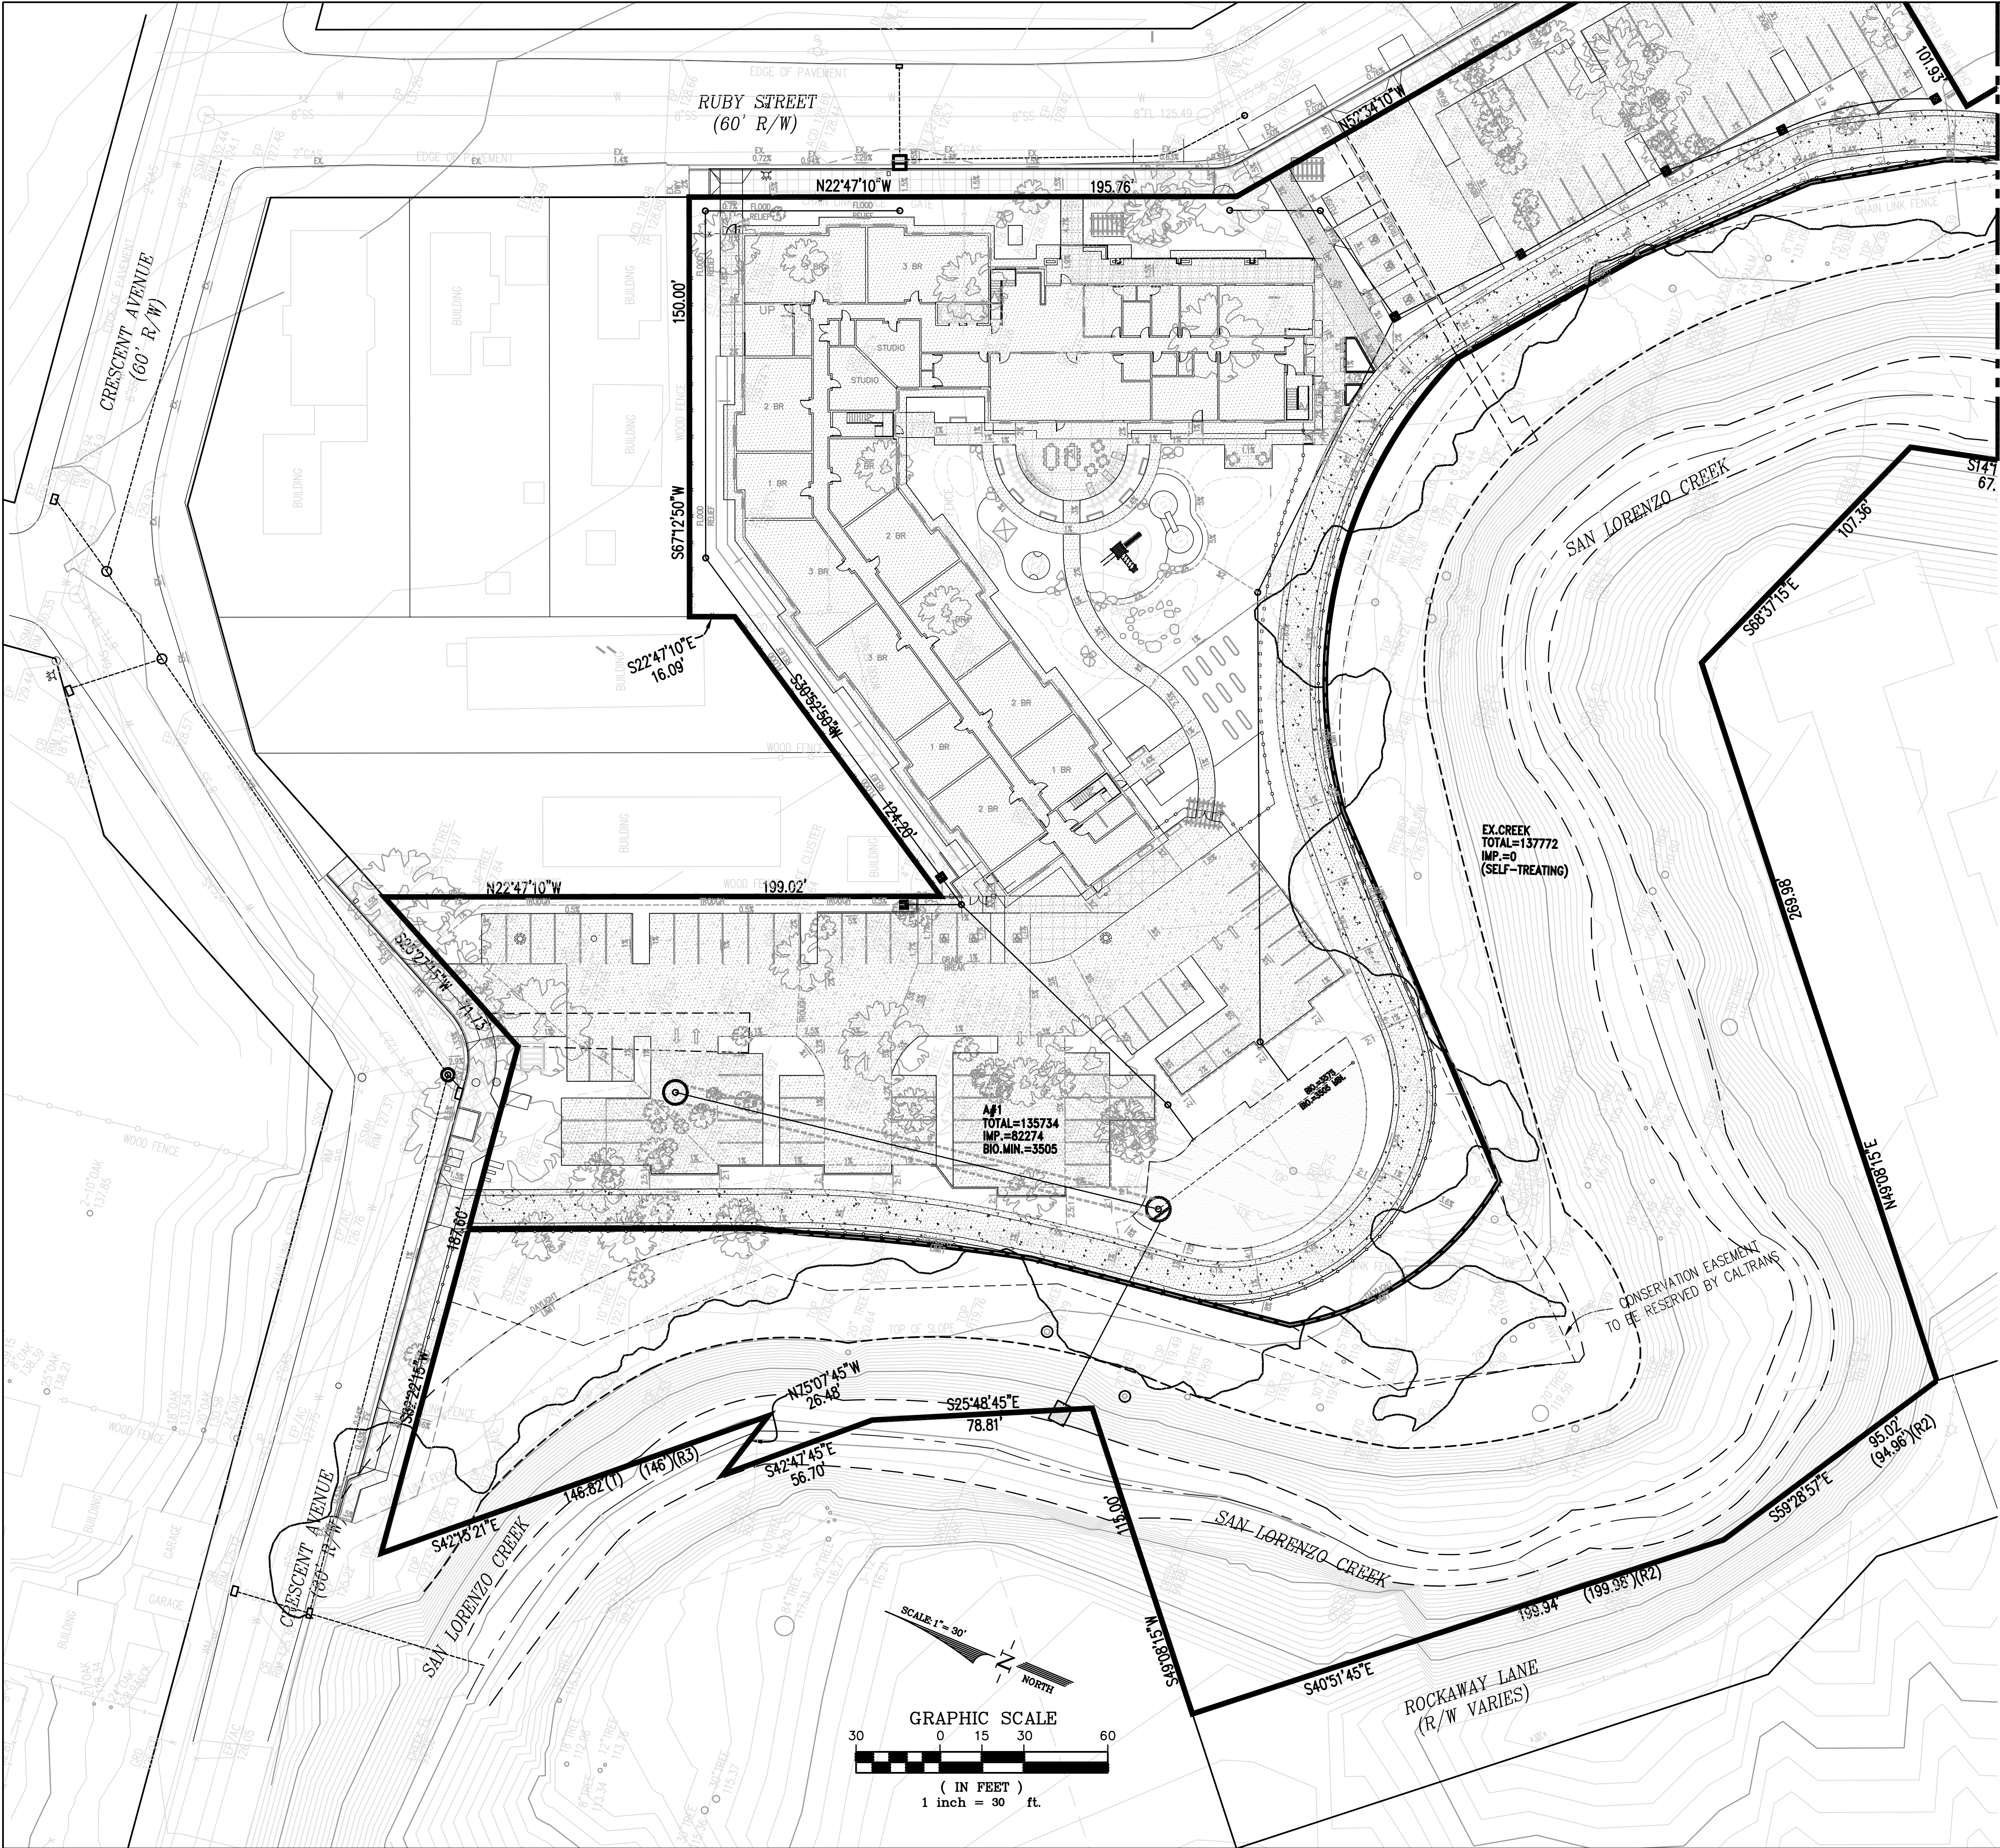CRITERIA APPLY TO BIORETENTION FACILITY (FOR TREATMENT AND FLOW CONTROL):

- SIZING FACTOR (SF) [BIORETENTION FACILITY] = 4%
- SURFACE RESERVOIR DEPTH = 6 INCHES TYPICAL
- SOIL MIX DEPTH = 18 INCHES TYPICAL (5 IN/HR MIN.)
- UNDERDRAIN = 4 INCHES PVC PIPE MINIMUM.

4) FOR SELF-RETAINING AREAS, THE RATIO OF IMPERVIOUS TO PERVIOUS AREA SHALL BE LESS THAN OR EQUAL TO 2:1 (TREATMENT ONLY) OR 1:1 (TREATMENT & FLOW CONTROL). SELF-RETAINING AREAS SHALL CAPTURE AND FLOW CONTROL A 1" PRECIPITATION DEPTH PER COUNTY DESIGN STANDARDS*.

5) FOR SELF-TREATING AREAS, THE PERCENTAGE OF IMPERVIOUS AREA MUST BE LESS THAN 5% PER COUNTY DESIGN STANDARDS*.

* TREATMENT SIZING CRITERIA ESTABLISHED BY ALAMEDA COUNTY

STORM TREATMENT DESIGN (PER ALAMEDA COUNTY)							
DMA & IMP NAME	TYPE	A SIZING FACTOR	D.M. AREA (S.F.)	RUNOFF SURFACE TYPE	C-FACTOR ADJUSTMENT VALUE	MIN. SIZE (S.F.)	PLANNED SIZE (S.F.)
A1	BIO-RETENTION AREA	4% *	82274	IMPERVIOUS	N/A	3505	3575
		0.4%	53460	PERVIOUS	N/A		
		0.4%	0	PERM.-PAVERS	N/A		
EX.CREEK	SELF-TREATING AREA	4% *	0	IMPERVIOUS	N/A	N/A	N/A
		0.4%	137772	PERVIOUS	N/A		
		0.4%	0	PERM.-PAVERS	N/A		

LEGEND

- IMPERVIOUS SURFACE
- BIORETENTION AREA
- DRAINAGE MANAGEMENT AREA LIMIT
- AREA#

 DRAINAGE MANAGEMENT AREA
- TOTAL =

 TOTAL DRAINAGE AREA
- IMP. =

 IMPERVIOUS AREA

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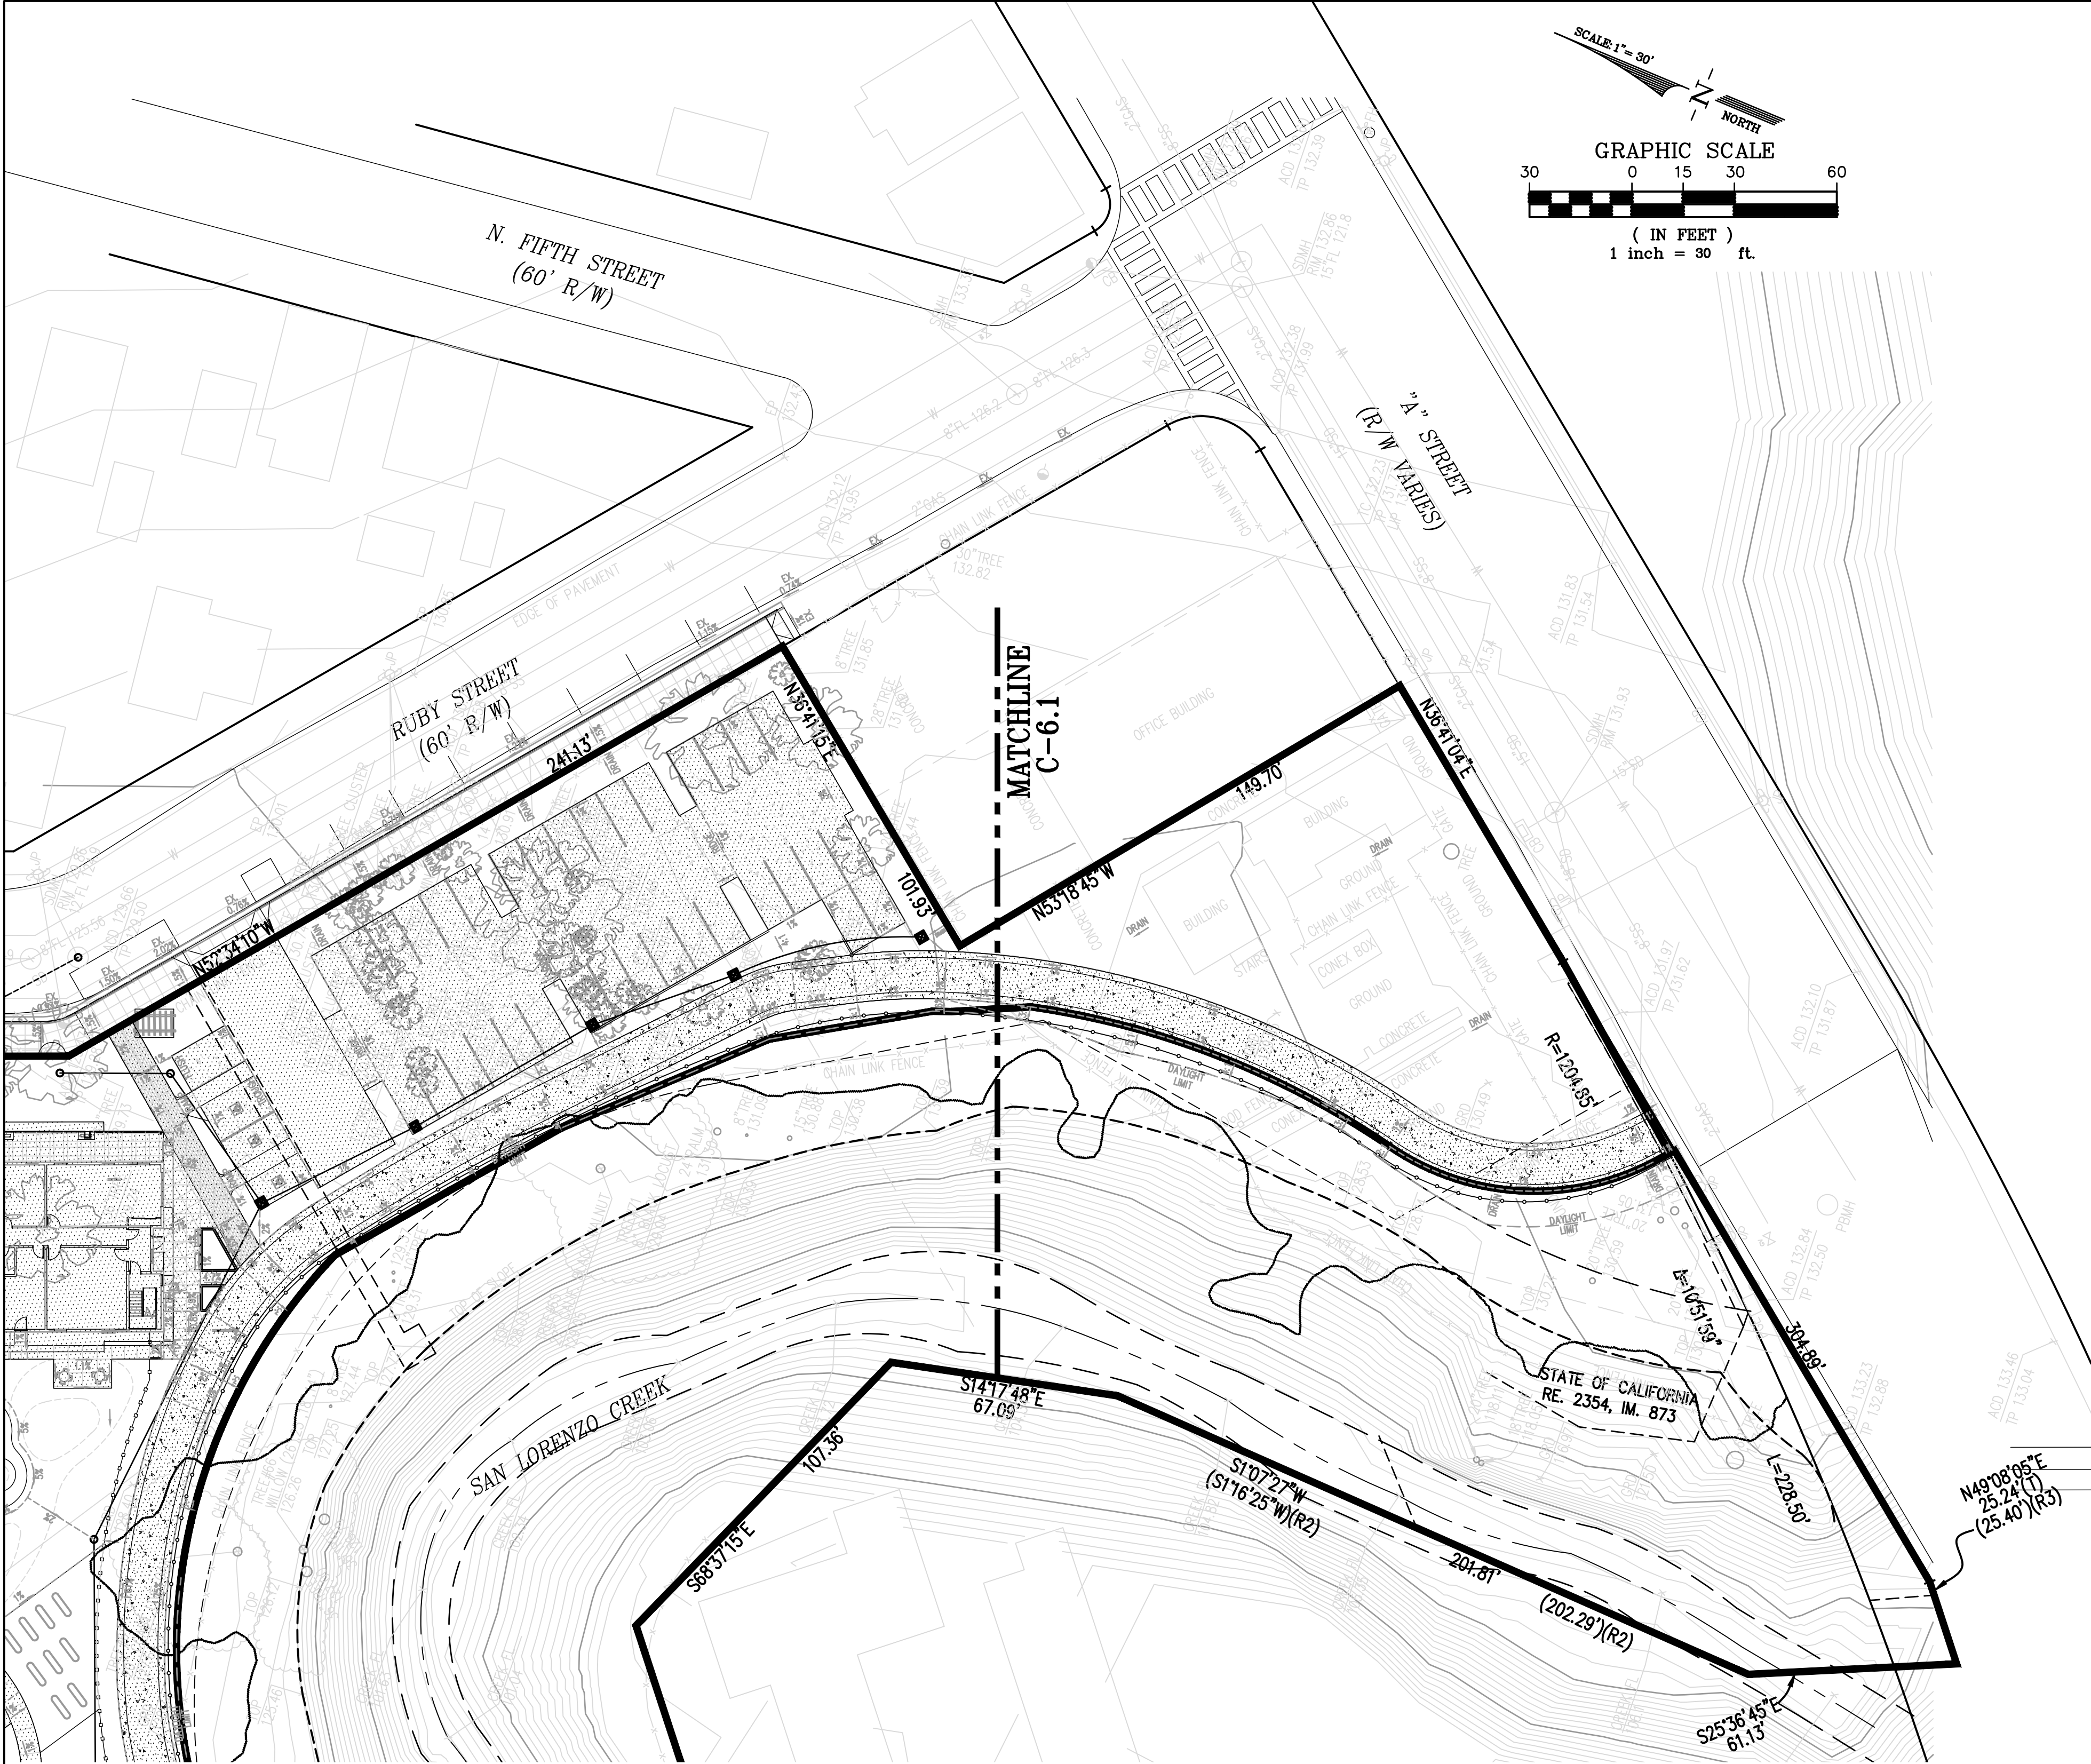
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JOB NUMBER:	10004A10
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TITLE:	PRELIMINARY STORMWATER TREATMENT PLAN

SHEET:

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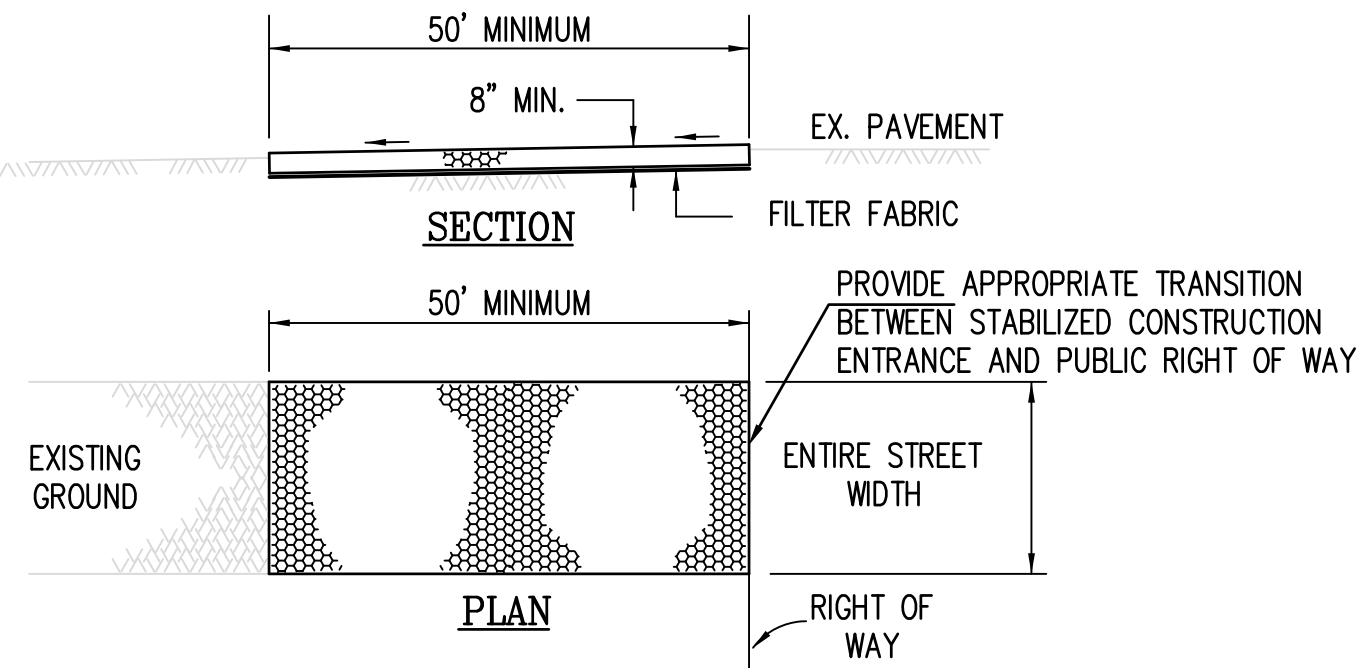
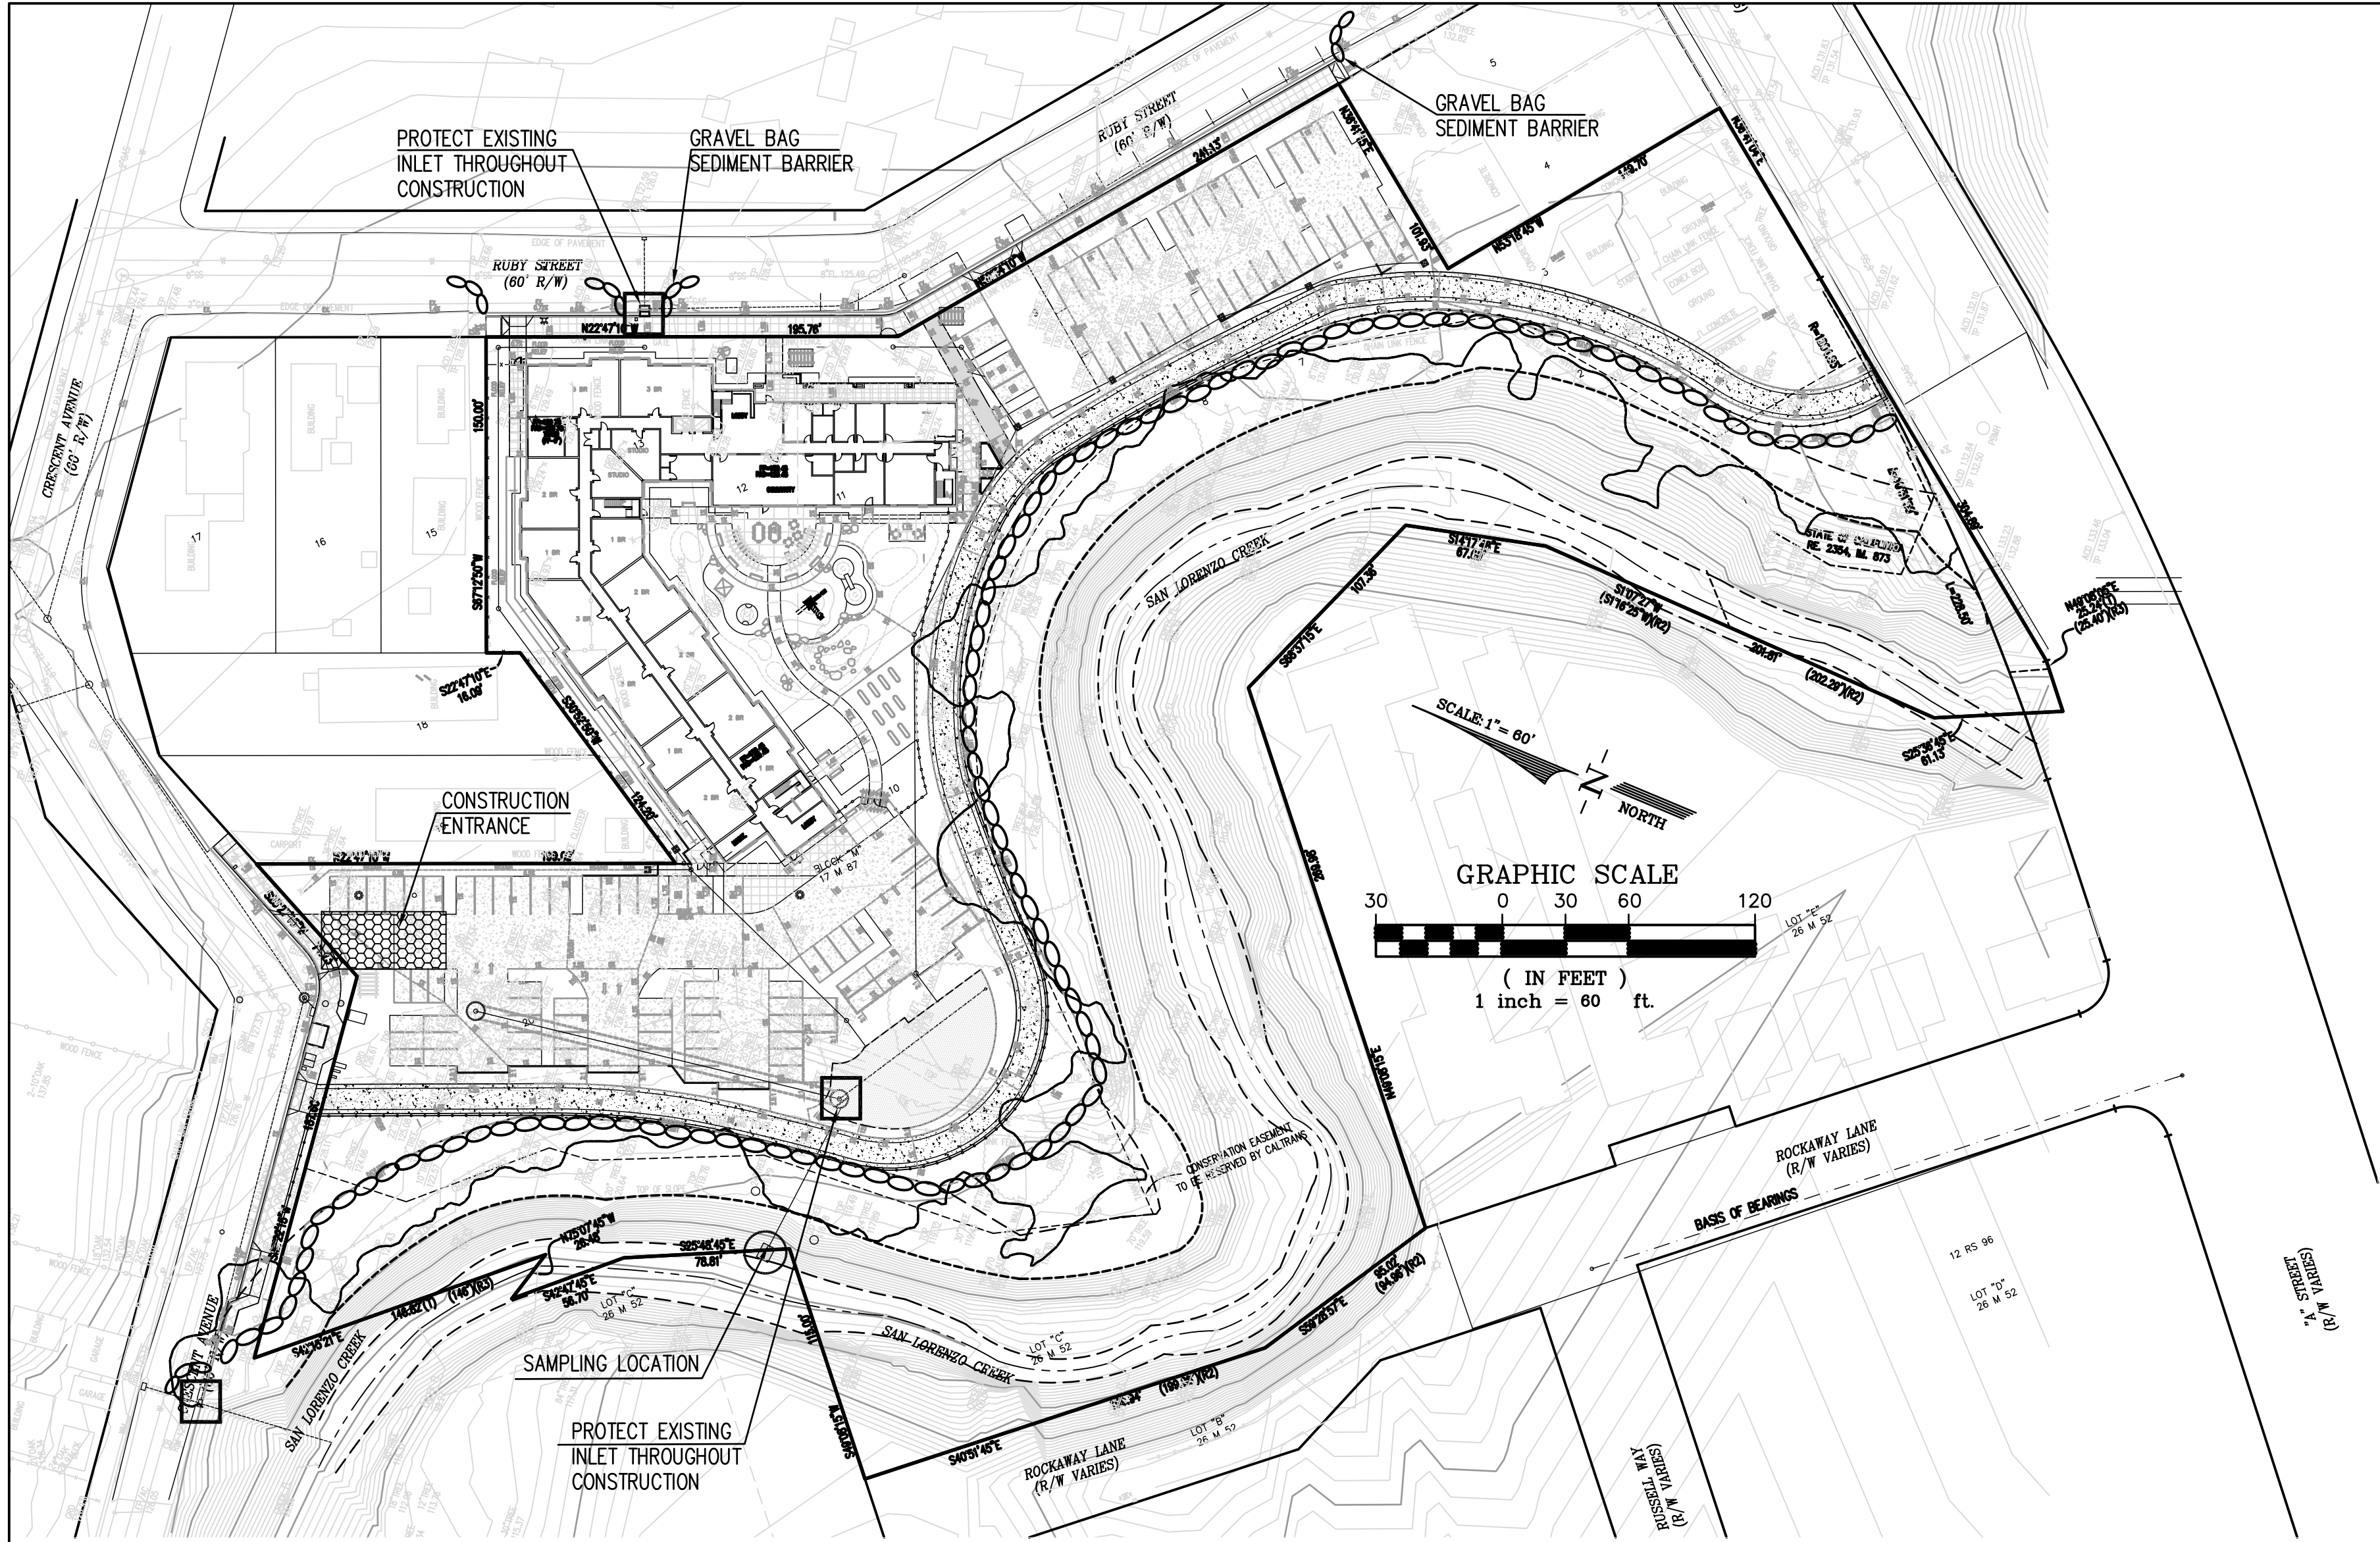
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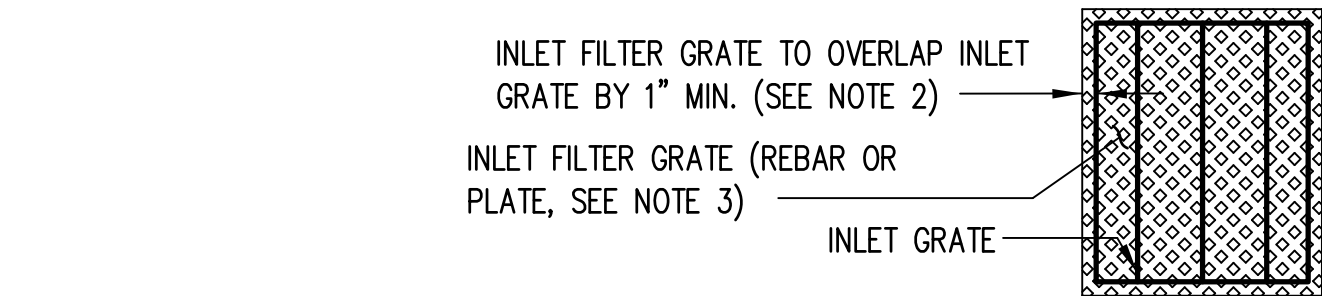
REFER TO STORM WATER POLLUTION PREVENTION PLAN FOR MORE DETAILS.
ALSO REFER TO THE RWQCB OR ABAG EROSION CONTROL MEASURE MANUAL.

CONSTRUCTION SPECIFICATIONS

- CONSTRUCTION AND MAINTENANCE OF THE COMPOST FILTER SOCK CAN BE FOUND AT WWW.TOPSPRAY.COM/EROSIONCONTROL/FILTERSOXX153/TABID/155/DEFAULT.ASPX
- THE MATERIAL FOR CONSTRUCTION SHALL BE 3 TO 4 INCH ROCK.
- LENGTH – AS EFFECTIVE, BUT NOT LESS THAN 50 FEET.
- THICKNESS – NOT LESS THAN EIGHT (8) INCHES.
- WIDTH – NOT LESS THAN FULL WIDTH OF ALL POINTS OF INGRESS OR EGRESS.
- WASHING – WHEN NECESSARY, WHEELS SHALL BE CLEANED TO REMOVE SEDIMENT PRIOR TO ENTRANCE ONTO PUBLIC RIGHT OF WAY. WHEN WASHING IS REQUIRED, IT SHALL BE DONE ON AN AREA STABILIZED WITH CRUSHED STONE WHICH DRAINS INTO AN APPROVED SEDIMENT TRAP OR SEDIMENT BASIN. ALL SEDIMENT SHALL BE PREVENTED FROM ENTERING ANY STORM DRAIN, DITCH, OR WATERCOURSE THROUGH USE OF SAND BAGS, GRAVEL BOARDS OR OTHER APPROVED METHODS.
- MAINTENANCE – THE ENTRANCE SHALL BE MAINTAINED IN A CONDITION WHICH WILL PREVENT TRACKING OR FLOWING OF SEDIMENT ONTO PUBLIC RIGHT OF WAY. THIS MAY REQUIRE PERIODIC TOP DRESSING WITH ADDITIONAL STONE AS CONDITIONS DEMAND AND REPAIR AND/OR CLEANOUT OF ANY MEASURES USED TO TRAP SEDIMENT. ALL SEDIMENT SPILLED, DROPPED, WASHED OR TRACKED ONTO PUBLIC RIGHT OF WAY MUST BE REMOVED IMMEDIATELY.

CONSTRUCTION ENTRANCE DETAIL


NOT TO SCALE



INLET PROTECTION DETAIL


(ALL AREAS)

NOT TO SCALE

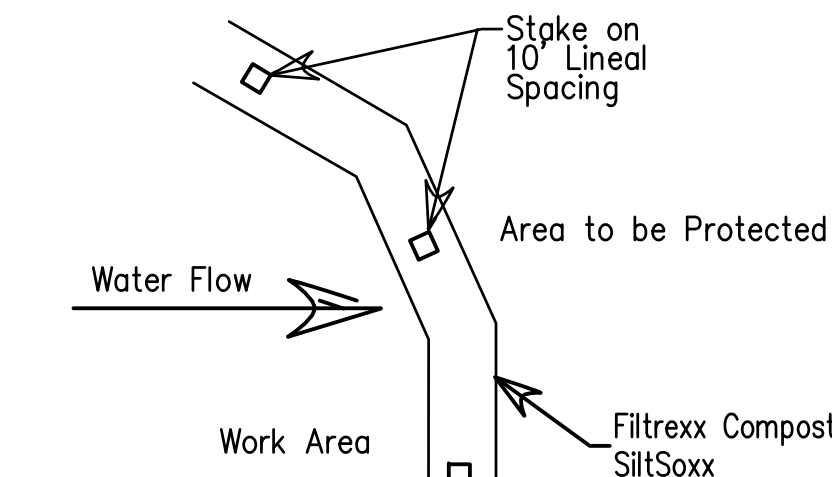

Filtrexx SiltSoxx PLAN VIEW

NOT TO SCALE

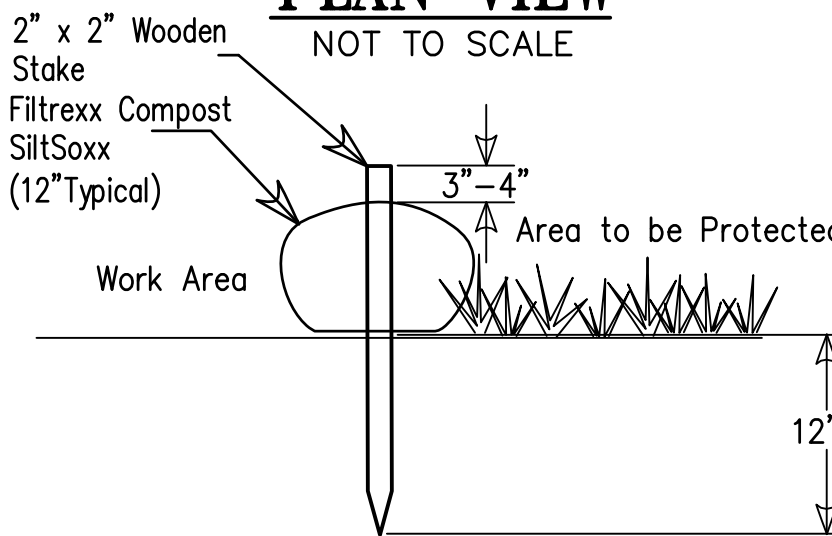

Filtrexx SiltSoxx SECTION

NOT TO SCALE

NOTES:

- ALL MATERIAL TO MEET FILTREXX SPECIFICATIONS. SPECIFICATION CAN BE FOUND AT <http://www.filtrexx.com/4.1.1%20SWPPP%20-%20SiltSoxx.pdf>
- SILTSOXX COMPOST TO MEET APPLICATION REQUIREMENTS.
- SILTSOXX DEPICTED IS FOR MINIMUM SLOPES. GREATER SLOPES MAY REQUIRE LARGER SOCKS PER THE ENGINEER.
- COMPOST MATERIAL TO BE DISPERSED ON SITE, AS DETERMINED BY ENGINEER.
- FILTER MATERIAL AND GRATE SHALL OVERLAP INLET ON ALL SIDES BY A MINIMUM OF 1\".
- INLET FILTER GRATE SHALL BE MADE OF #3 RE-BARS, CRISS CROSSED AT 6\"(WELDED OR TIED TOGETHER WITH WIRE) OR A PLATE WITH A MINIMUM OF 75% OPEN AREA, BOTH OF SUFFICIENT STRENGTH TO PREVENT BENDING WHEN DRIVEN OVER BY A VEHICLE.
- INLET FILTER GRATE SHALL BE SECURELY ATTACHED TO DRAIN INLET BY WIRE OR TIE-WRAP(S/BEND OVER).
- FILTERS SHALL BE INSPECTED WEEKLY AND BEFORE AND AFTER EACH RAINFALL. REPAIRS, SEDIMENT/DEBRIS REMOVAL SHALL BE MADE TO ASSURE EFFICIENCY FUNCTIONING OF FILTER SYSTEM.

LEGEND

- COMPOST FILTER SOCK
- GRAVEL CONSTRUCTION ENTRANCE AND WASH AREA
- STORM INLET PROTECTION
- SAMPLING LOCATION

EROSION CONTROL NOTES:

- CONTRACTOR IS RESPONSIBLE FOR ALL ASPECTS OF "EROSION CONTROL" AND SHALL INSTALL AND MAINTAIN ANY DEVICES AND MEASURES NECESSARY TO THE SATISFACTION OF THE COUNTY ENGINEER DURING THE ENTIRE CONSTRUCTION PERIOD.
- THE CONTRACTOR SHALL PLACE COARSE DRAIN ROCK AS A GRAVEL ROADWAY (8" MIN. THICK FOR THE FULL WIDTH AND 50' LONG) AT EACH ENTRANCE TO THE SITE. ANY MUD THAT IS TRACKED ONTO PUBLIC STREETS SHALL BE REMOVED THAT SAME DAY AND AS REQUIRED BY THE COUNTY INSPECTOR.
- ALL EROSION CONTROL MEASURES SHALL BE MAINTAINED UNTIL DISTURBED AREAS ARE STABILIZED AND CHANGES TO THIS EROSION AND SEDIMENT CONTROL PLAN SHALL BE MADE TO MEET FIELD CONDITIONS ONLY WITH THE APPROVAL OF OR AT THE DIRECTION OF THE COUNTY ENGINEER.
- DURING THE ENTIRE CONSTRUCTION PERIOD, ALL PAVED AREAS SHALL BE KEPT CLEAR OF EARTH MATERIAL AND DEBRIS. THE SITE SHALL BE MAINTAINED TO MINIMIZE SEDIMENT-LADEN RUNOFF TO ANY STORM DRAINAGE SYSTEM.
- THIS PLAN COVERS ONLY THE FIRST WINTER FOLLOWING GRADING. PLANS ARE TO BE RE-SUBMITTED FOR COUNTY APPROVAL PRIOR TO SEPTEMBER 1 OF EACH SUBSEQUENT YEAR UNTIL THE SITE IMPROVEMENTS ARE ACCEPTED BY THE COUNTY.
- ALL EROSION CONTROL FACILITIES MUST BE INSPECTED AND REPAIRED AT THE END OF EACH WORKING DAY OR DAILY DURING THE ENTIRE CONSTRUCTION PERIOD.
- ANY SEDIMENT BASINS SHALL BE CLEARED OUT WHENEVER SEDIMENT REACHES THE SEDIMENT CLEANOUT LEVEL INDICATED ON THE PLANS.
- BORROW AREAS AND TEMPORARY STOCKPILES SHALL BE PROTECTED WITH APPROPRIATE EROSION CONTROL MEASURES TO THE SATISFACTION OF THE COUNTY ENGINEER.
- ALL CUT AND FILL SLOPES ARE TO BE PROTECTED TO PREVENT OVERBACK FLOW.
- THIS PLAN MAY NOT COVER ALL SITUATIONS THAT ARISE DURING CONSTRUCTION DUE TO ANTICIPATED FIELD CONDITIONS. VARIATIONS MAY BE MADE TO THE PLAN IN THE FIELD, SUBJECT TO THE APPROVAL OF THE COUNTY.
- HYDROSEED ALL CUT AND FILL SLOPES WHICH ARE STEEPER THAN 5% WITH THE FOLLOWING (VOLUMES SHOWN ARE PER ACRE OF SLOPE):

FERTILIZER: 500 LBS. 16-6-8
SEED: 60 LBS. BLANDO BROME GRASS
60 LBS. ANNUAL RYE GRASS
30 LBS. ROSE CLOVER
CHEMICAL TACKIFIER 2000 LBS. WOOD CELLULOSE
30 LBS. ORGANIC BINDER

- TO CONTROL EROSION WITHIN THE STREET RIGHT-OF-WAY, FIBER ROLLS, SANDBAGS, EARTH BERMS OR OTHER SUITABLE MATERIALS SHALL BE PLACED WITHIN ALL UNPAVED STREETS DURING THE ENTIRE CONSTRUCTION PERIOD. THESE ROLLS OF FIBER SHALL BE PLACED AS SHOWN ON PLAN OR AS REQUIRED BY THE CITY ENGINEER (SEE FIBER ROLL DETAIL, THIS SHEET). THE ROLLS SHALL BE SECURELY ANCHORED IN PLACED BY STAKES OR REBARS DRIVEN THROUGH THE ROLLS WITH THE FIRST STAKE IN EACH ROLL ANGLED TOWARD THE PREVIOUSLY LAID ROLL. TO FORCE THEM TOGETHER. THE ROLLS SHALL BE MAINTAINED IN GOOD CONDITION FOR THE ENTIRE CONSTRUCTION PERIOD UNTIL THE STREET IS PAVED. ROLLS OF FIBER OR OTHER SUITABLE MATERIALS SHALL BE USED TO PREVENT SEDIMENT LADEN RUNOFF FROM ENTERING ANY PARTIALLY COMPLETED STORM DRAIN SYSTEM.


- TO MINIMIZE STORM WATER RUNOFF FROM THE SITE, FIBER ROLLS SHALL BE CONSTRUCTED ON EACH PAD AS IT IS GRADED. THE FIBER ROLLS SHALL BE 1-FOOT MINIMUM IN HEIGHT AND PLACED SO THE STORM WATER FALLING ONTO THE PAD AREA AND THE SURROUNDING UPHILL BANKS WILL BE TRAPPED ON THE PAD. THE CONTRACTOR IS RESPONSIBLE FOR INSPECTING AND REPAIRING THE ROLLS ON EACH PAD DURING THE ENTIRE CONSTRUCTION PERIOD AND MAINTAINING THEM IN GOOD CONDITION UNTIL THE BUILDING CONSTRUCTION IS COMPLETED. THE CONTRACTOR SHALL ENSURE COMPLIANCE WITH THE REQUIREMENTS REGARDING PAD MOISTURE CONTENT, COMPACTION, AND ALL OTHER CONDITIONS SET FORTH BY THE GEOTECHNICAL ENGINEER.

- WHEN TEMPORARY STRUCTURES HAVE SERVED THEIR INTENDED PURPOSE AND THE CONTRIBUTING DRAINAGE AREA HAS BEEN PROPERLY STABILIZED, THE ENBANKMENT AND RESULTING SEDIMENT DEPOSITS ARE TO BE LEVELED OR OTHERWISE DISPOSED OF AS RECOMMENDED BY THE GEOTECHNICAL ENGINEER.

- CONTRACTOR IS RESPONSIBLE FOR ALL AGENCY EROSION CONTROL PLANS AND PAPERWORK AND IS RESPONSIBLE FOR ALL CLOSURES OF THESE FILINGS.

- ALL GRADED OR DISTURBED AREAS THAT WILL BE IDLE DURING THE RAINY SEASON SHALL BE MULCHED AT THE MINIMUM RATE OF TWO TONS PER ACRE.

- CONTRACTOR TO REFER TO STORM WATER POLLUTION PREVENTION PLAN (SWPPP) FOR EROSION CONTROL MEASURES DURING CONSTRUCTION.

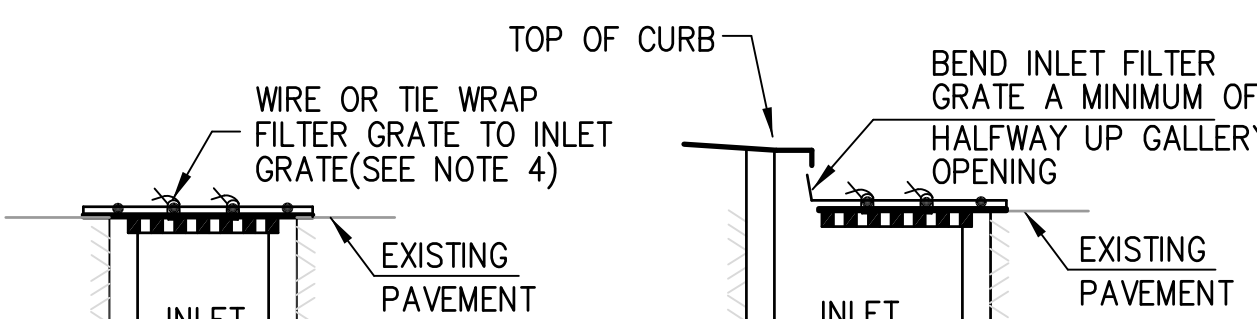


SECTION

INLET PROTECTION DETAIL

(PAVED AREAS)

NOT TO SCALE

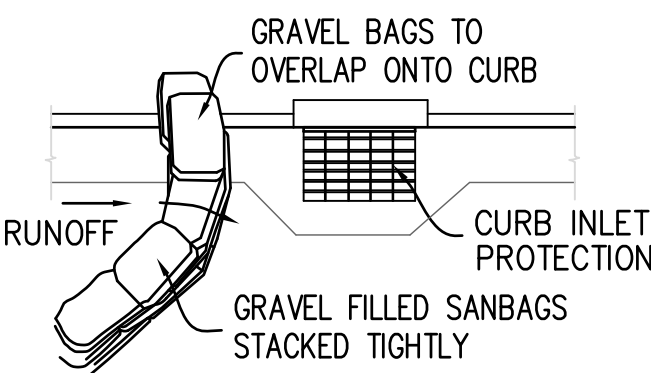

STREET GUTTER BARRIER

NOT TO SCALE

PYATOK

1611 TELEGRAPH AVE. SUITE 200
OAKLAND, CA 94612
510.465.7010 p | 510.465.8575 f
www.pyatok.com

EDEN HOUSING

22645 Grand St, Hayward, CA 94541

RUBY ST
Ruby St, Castro Valley, CA 94546

STAMP:

Luk and Associates

Civil Engineering
Land Planning
Land Surveying
738 Alfred Nobel Drive
Hercules, CA 94547
Phone (510) 724-3388
Fax (510) 724-3383

REVISION SCHEDULE

No. ISSUE DATE

JOB NUMBER: 10004A10

DRAWN BY: CW

CHECKED BY: JL

DATE: JULY 9, 2019

SCALE: 1" = 30'

TITLE: PRELIMINARY EROSION CONTROL PLAN

SHEET:

C-7.1

PRELIMINARY - Not for Construction -

© 2017 PYATOK ARCHITECTURE & URBAN DESIGN

Plot Date: 01/17/2020






SHADE TREES AT
PARKING


NATIVE OR NATIVE-LIKE
SHADE TREES

LEGEND


- 1 PLAY MOUNDS
- 2 FULL CALTRANS TRAIL 10' WIDE ASPHALT WITH 2' DECOMPOSED GRANITE SHOULDERS
- 3 GALVANIZED VEGETABLE PLANTERS
- 4 WOOD TRELLIS
- 5 BENCH, TYPICAL
- 6 ROCK/BOULDER MOUND
- 7 BBQ AND COUNTER
- 8 PLAY AREA, AGES 5-12
- 9 PLAY AREA, AGES 2-5
- 10 DECOMPOSED GRANITE PAVING
- 11 COMMUNITY GATHERING AREA
- 12 ENTRY PLAZA
- 13 EXISTING TREE TO REMAIN, TYPICAL
- 14 TREE GROVE
- 15 DECOMPOSED GRANITE FIRE ACCESS PATH
- 16 6' HIGH FENCE, ORNAMENTAL METAL, SEE DETAIL 2/L2.1
- 17 6' HIGH GOOD NEIGHBOR FENCE - WOOD, SEE DETAIL 1/L2.1
- 18 ORNAMENTAL METAL GATE, TYP.
- 19 RESILIENT PAVING PLAY SURFACING
- 20 BOLLARD AND WIRE ROPE FENCING, SEE DETAIL 3/L2.1
- 21 PUBLIC TRAIL ACCESS

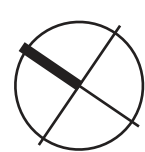


0 5' 10' 20'

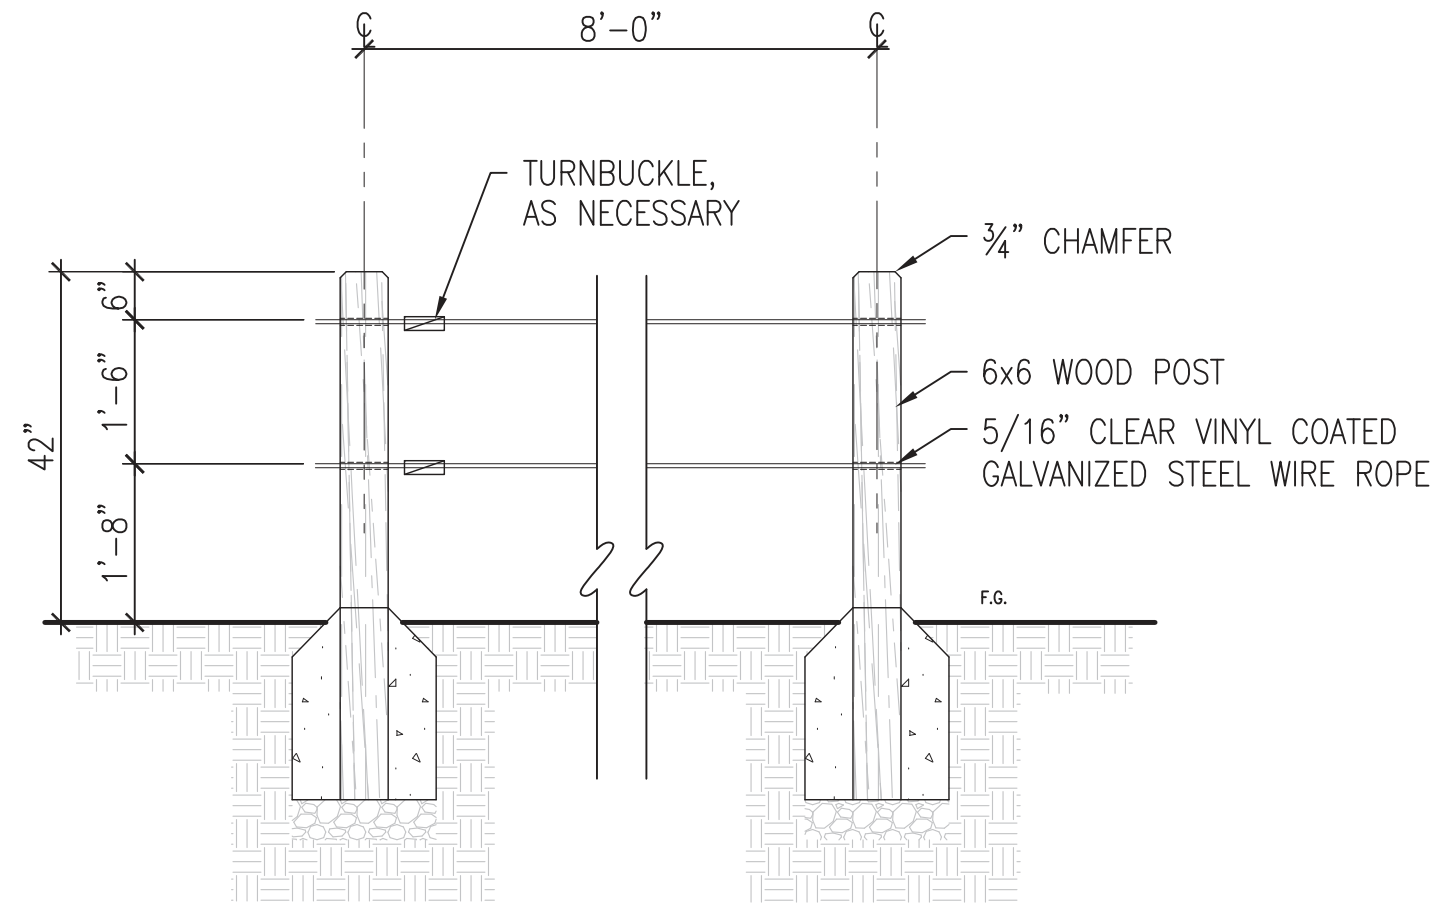


3 BOLLARD AND WIRE ROPE FENCING
SCALE: 1/2" = 1'-0"

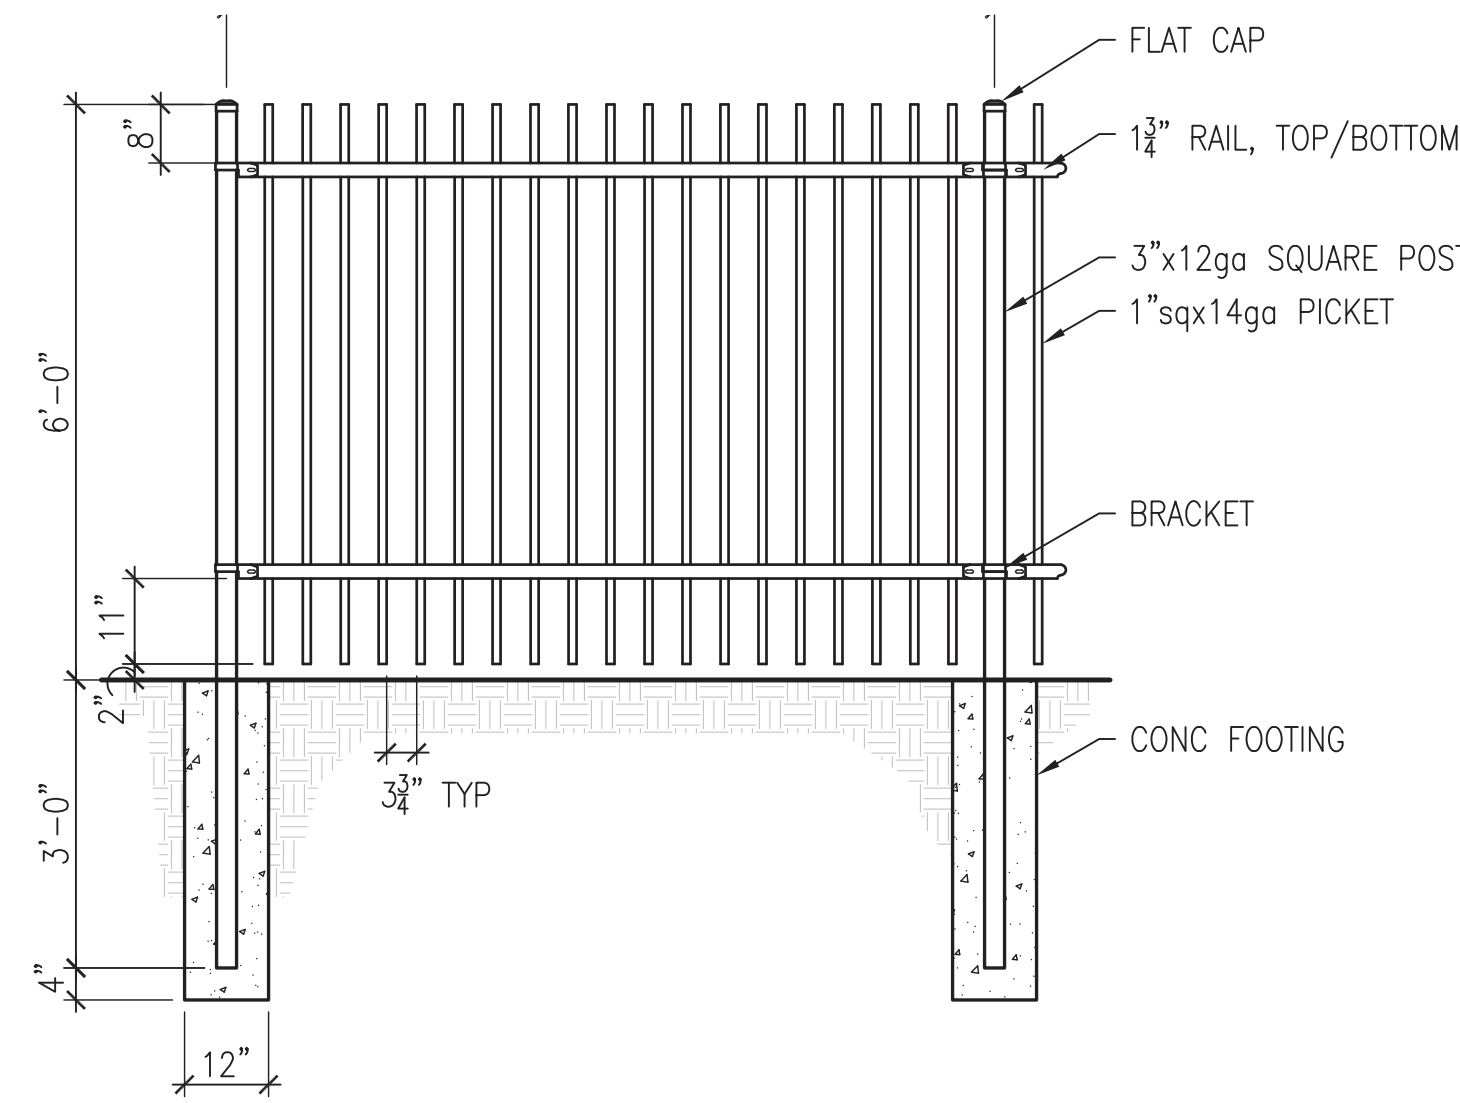

2 ORNAMENTAL METAL FENCE
SCALE: 1" = 1'-0"

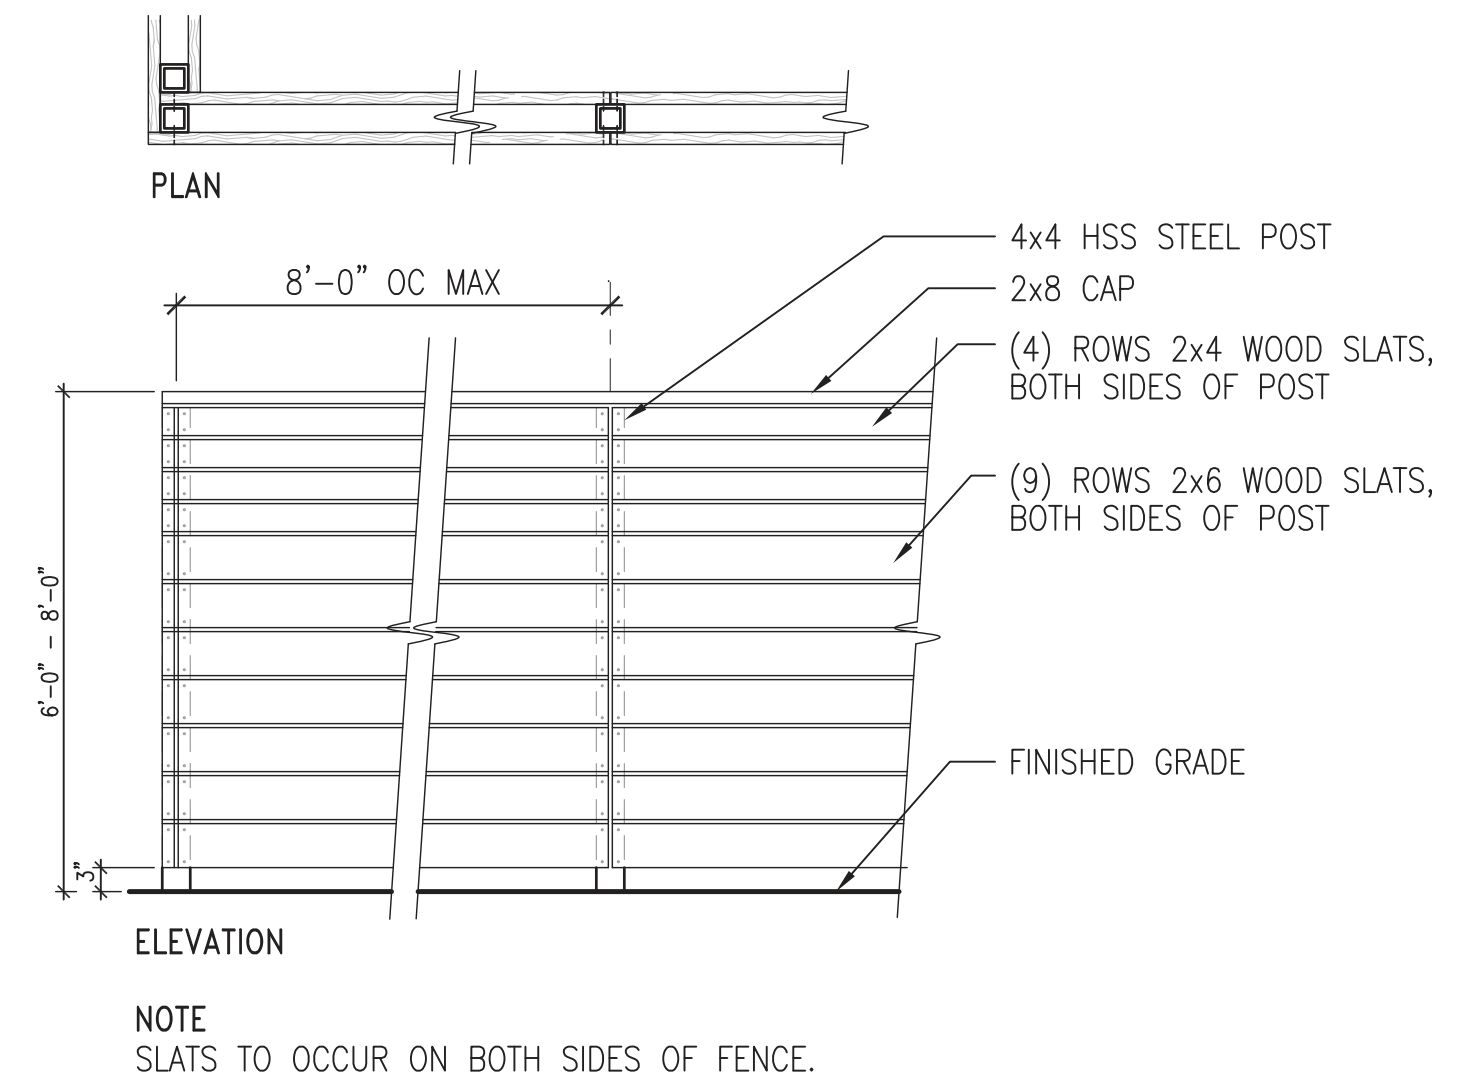

1 WOOD GOOD-NEIGHBOR FENCE
SCALE: 1/2" = 1'-0"

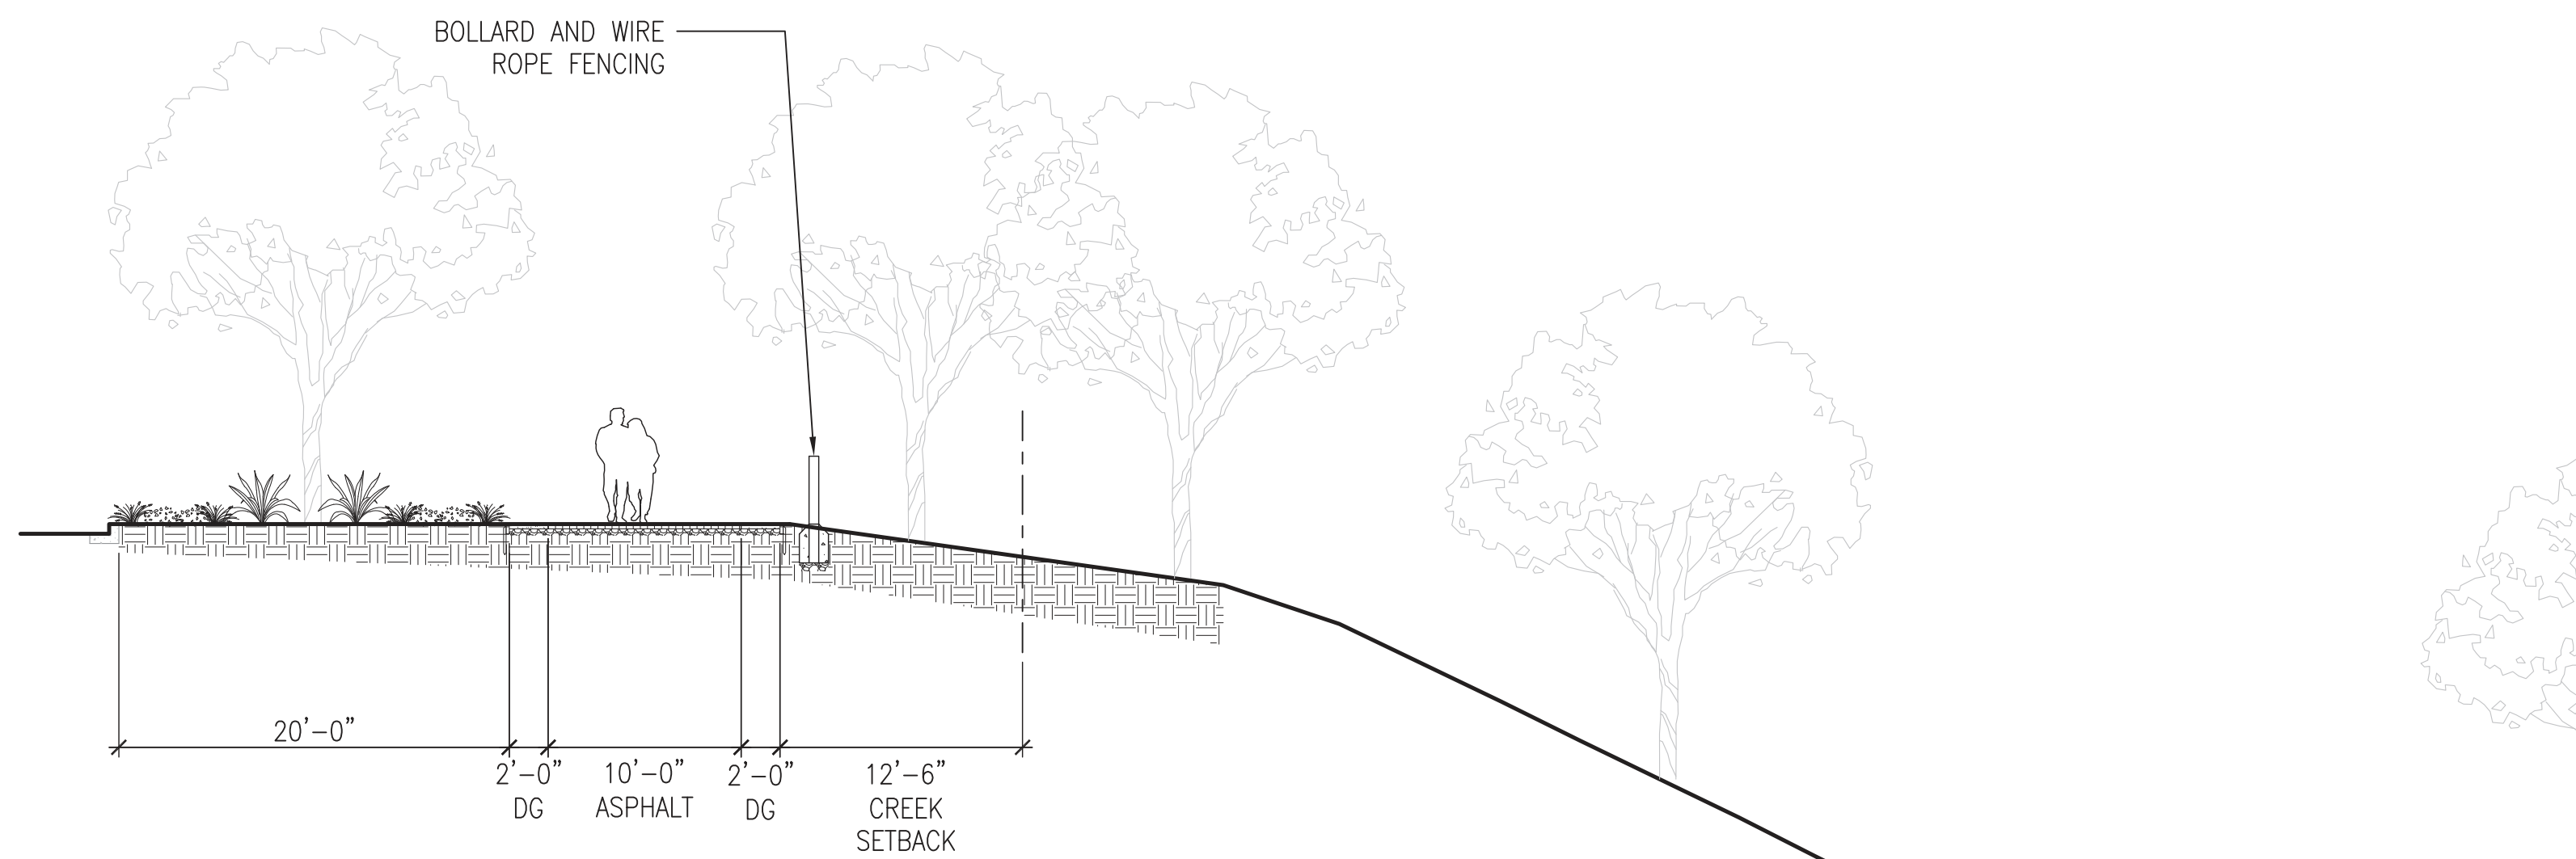

4 OPTION B SECTION AT TRAIL
SCALE: 1/8" = 1'-0"



GALVANIZED VEGETABLE PLANTERS



COMMUNITY GATHERING AREA



BIORETENTION BASIN



ROCK/BOULDER MOUND



WOOD TRELLIS



PLAY STRUCTURE



PLAY MOUNDS



PRELIMINARY PLANT PALETTE					
SYMBOL	BOTANICAL NAME	COMMON NAME	SIZE	SPACING	WTR USE
STREET TREES					
	GINKGO BILOBA 'AUTUMN GOLD'	MAIDENHAIR TREE	24" BOX	PER PLAN	M
SHADE TREE - PARKING					
	PLATANUS ACERIFOLIA	LONDON PLANE TREE	24" BOX	PER PLAN	M
SHADE TREE - NATIVE TREES					
	QUERCUS AGRIFOLIA	COAST LIVE OAK	24" BOX	PER PLAN	L
	QUERCUS LOBATA	VALLEY OAK	24" BOX	PER PLAN	L
FOCAL POINT TREE					
	QUERCUS LOBATA	VALLEY OAK	36" BOX	PER PLAN	L
SCREENING TREES					
	PODOCARPUS GRACILIOR	FERN PODOCARPUS	24" BOX	PER PLAN	M
	TRISTANOOPSIS LAURINA	WATER GUM	24" BOX	PER PLAN	M
SMALL ACCENT TREES					
	LAGERSTROEMIA INICA	CRAPE MYRTLE	24" BOX	PER PLAN	L
	ACER PALMATUM	JAPANESE MAPLE	24" BOX	PER PLAN	M
LARGE SHRUBS					
	ARCTOSTAPHYLOS X 'SUNSET'	SUNSET MANZANITA	5 GAL	6'-0" OC	L
	CARPENTERIA CALIFORNICA	ELIZABETH BUSH ANEMONE	5 GAL	4'-0" OC	L
	CEANOTHUS 'DARK STAR'	CALIFORNIA LILAC	5 GAL	5'-0" OC	L
	MYRICA CALIFORNICA	PACIFIC WAX MYRTLE	5 GAL	9'-0" OC	M
	PITTIOSPORUM TOBIRA 'VARIEGATA'	VARIEGATED MOCK ORANGE	5 GAL	4'-0" OC	L
	RHAMNUS CALIFORNICA	COFFEEBERRY	5 GAL	7'-0" OC	L
MEDIUM SHRUBS, GRASSES, & PERENNIALS					
	ACHILLEA COGNATA 'COUSIN ITT'	LITTLE RIVER WATTLE	5 GAL	3'-0" OC	L
	AGAVE ATTENUATA	BLUE FOX TAIL AGAVE	5 GAL	3'-0" OC	L
	BUXUS 'GREEN MOUNTAIN'	GREEN MNTN BOXWOOD	5 GAL	3'-0" OC	M
	CHONDRPETALUM TECTORUM	CAPE RUSH	1 GAL	3'-0" OC	L
	DIETES BICOLOR	FORTNIGHT LILY	1 GAL	3'-0" OC	L
	CORREA 'WYNS WONDER'	AUSTRALIAN FUCHSIA	5 GAL	3'-0" OC	L
	GREVILLEA 'SCARLET SPRITE'	GREVILLEA	5 GAL	4'-0" OC	L
	LOMANDRA LONGIFOLIA 'BREEZE'	DWARF MAT RUSH	1 GAL	3'-0" OC	L
	LOROPETALUM 'SUZANNE'	FRINGE FLOWER	5 GAL	4'-0" OC	L
	MUHLENBERGIA RIGENS	DEER GRASS	1 GAL	4'-0" OC	L
	PHORMIUM HYBRID	NEW ZEALAND FLAX	5 GAL	3'-0" OC	L
	PITTIOSPORUM 'WHEELERS DWARF'	VARIEGATED MOCK ORANGE	5 GAL	4'-0" OC	L
	POLYSTICHUM MUNITUM	WESTERN SWORD FERN	1 GAL	3'-0" OC	M
SMALL SHRUBS, GRASSES, & PERENNIALS					
	ACHILLEA SP	YARROW	1 GAL	2'-0" OC	L
	ANIGOZANTHOS 'BUSH TANGO'	KANGAROO PAWS	5 GAL	2'-0" OC	L
	ASPIDISTRA ELATIOR	CAST IRON PLANT	1 GAL	2'-0" OC	L
	LIMONIUM PEREZII	SEA LAVENDER	1 GAL	3'-0" OC	L
	LIRIOPE 'SILVER DRAGON'	SILVER Y LILYTURF	1 GAL	2'-0" OC	M
GROUNDCOVERS					
	ARCTOSTAPHYLOS UVA URSI	GREEN SUPREME MANZANITA	1 GAL	5'-0" OC	L
	'GREEN SUPREME'				
	CEANOTHUS GLORIOSUS 'ANCHOR BAY'	PT. REYES CEANOTHUS	1 GAL	5'-0" OC	L
	COPROSMA KIRKII 'VARIEGATA'	CREeping MIRROR PLANT	1 GAL	4'-0" OC	L
	LANTANA MONTEVIDENSIS	PURPLE TRAILING LANTANA	1 GAL	8'-0" OC	L
	SARCOCOCCA H. VAR HUMILIS	HIMILAYAN SWEET BOX	1 GAL	3'-0" OC	L
NATIVE SHRUBS AND GROUNDCOVER AT CREEK TRAIL					
	ACHILLEA SPP	YARROW	1 GAL	2'-0" OC	L
	ARCTOSTAPHYLOS SPP	MANZANITA	1 GAL	TBD	L
	CEANOTHUS SPP	CALIFORNIA LILAC	1 GAL	TBD	L
	MUHLENBERGIA RIGENS	DEER GRASS	1 GAL	3'-0" OC	L
	RHAMNUS CALIFORNICA	COFFEEBERRY	1 GAL	6'-0" OC	L
	EPILOBIUM CANUM	CALIFORNIA FUCHSIA	1 GAL	TBD	L
STORMWATER PLANTING MIX					
	CAREX DIVULSA	BERKELEY SEDGE	1 GAL	2'-0" OC	L
	CHONDRPETALUM TECTORUM	CAPE RUSH	3 GAL	3'-0" OC	L
	IRIS PACIFIC COAST HYBRIDS	PCH IRIS	1 GAL	2'-0" OC	L
	JUNCUS PATENS	CALIFORNIA GRAY RUSH	1 GAL	2'-0" OC	L
	SYRINCHIUM BELLUM	BLUE-EYED GRASS	1 GAL	3'-0" OC	L
	DIETES SPP.	FORTNIGHT LILY	1 GAL	3'-0" OC	L

-
- EXISTING TREE TO REMAIN
-
- TREE TO BE REMOVED

GENERAL PLANTING & IRRIGATION NOTES

1. THESE PLANS SHALL COMPLY WITH THE CRITERIA OF THE CALIFORNIA MODEL WATER EFFICIENCY ORDINANCE AND APPLY THOSE CRITERIA FOR THE EFFICIENT USE OF WATER IN THE LANDSCAPE DESIGN PLAN.
2. CONTRACTOR TO PROVIDE AGRICULTURAL SOIL ANALYSIS DONE BY A QUALIFIED SOIL-TESTING LABORATORY.
3. ALL PLANTING AREAS SHALL BE TOP-DRESSED WITH A 3" LAYER OF ORGANIC, UN-DYED WALK-ON MULCH.
4. IRRIGATION SYSTEM IS TO BE A FULLY AUTOMATIC WEATHER-BASED SYSTEM USING LOW FLOW DRIP AND BUBBLER DISTRIBUTION.
5. 3:1 REPLACEMENT FOR ALL TREES REMOVED IN RIPARIAN CANOPY AREA

EDEN HOUSING

22645 Grand St, Hayward, CA 94541
(510) 582-1460



RUBY ST
Ruby St, Castro Valley, CA 94546

STAMP:

REVISION SCHEDULE
NO. | ISSUE | DATE

JOB NUMBER: 1744
DRAWN BY: Author
CHECKED BY: Checker
DATE: 01/27/2020
SCALE: 1" = 30'-0"
TITLE:

PRELIMINARY
PLANTING PLAN

SHEET:

L3.1

RUBY ST
Ruby St, Castro Valley, CA 94546

STAMP:

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REVISION SCHEDULE	
NO. ISSUE	DATE



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DRAWN BY:	Author
CHECKED BY:	Checker
DATE:	01/27/2020
SCALE:	1" = 30'-0"
TITLE:	TREE PROTECTION & REMOVAL PLAN




EXISTING TREE COUNTS		
SYMBOL	TYPE	COUNT
	TREES TO BE REMOVED	80
	TREES TO REMAIN	55
TOTAL TREES ON SITE		135

NOTE:
ALL TREES TO BE REMOVED IN THE RIPARIAN CANOPY ASSOCIATED WITH SAN LORENZO CREEK SHALL HAVE 3:1 REPLACEMENT RATIO



TREE MITIGATION COUNTS		
SYMBOL	TYPE	COUNT
	PROPOSED TREE, TYPICAL	96
	TREES TO REMAIN	54
TOTAL PROPOSED & EXISTING TREES TO REMAIN ON SITE		150

NOTE:
ALL TREES TO BE REMOVED IN THE RIPARIAN CANOPY ASSOCIATED WITH SAN LORENZO CREEK SHALL HAVE 3:1 REPLACEMENT RATIO

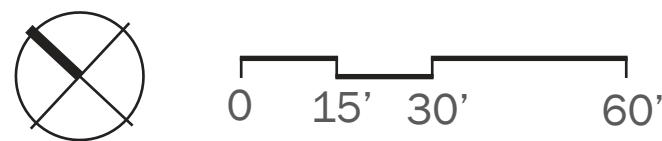

NOTES:

FIRE DEPARTMENT ACCESS KNOX BOXES WILL BE PROVIDED AT THE MAIN AND REAR ENTRY, AND AS DIRECTED BY THE FIRE DEPARTMENT

SHOWN LANDSCAPE PLAN IS CONCEPTUAL. REFER TO LANDSCAPE PLANS.

PROPOSED TREES AND OTHER LANDSCAPE ELEMENTS WILL BE ADJUSTED TO COMPLY FULLY WITH CBC SEC. 1030 EMERGENCY ESCAPE AND RESCUE FOR ALL SLEEPING ROOM WINDOWS BELOW THE FOURTH STORY.

UNIT COUNT BY FLOOR	
Name	Count
Level 1	
1 BR	4
2 BR	5
3 BR	4
STUDIO	2
15	

Level 2	
1 BR	10
2 BR	5
3 BR	6
STUDIO	2
23	

Level 3	
1 BR	9
2 BR	6
3 BR	4
STUDIO	2
21	

Level 4	
1 BR	4
2 BR	2
3 BR	5
STUDIO	2
13	
Grand Total	72


DWELLING UNIT MIX		
Unit Type	Count	Percentage
1 BR	27	38%
2 BR	18	25%
3 BR	19	26%
STUDIO	8	11%
Grand Total	72	100%

GROSS BUILDING AREA SCHEDULE	
Level	Area
LEVEL 01	22381 SF
LEVEL 02	22868 SF
LEVEL 03	20916 SF
LEVEL 04	13752 SF
Grand Total	79917 SF


PARKING SCHEDULE		
STALL TYPE	Count	Percentage
ACCESSIBLE	4	4%
ACCESSIBLE, VAN	2	2%
COMPACT	45	41%
COMPACT, TANDOM	7	6%
E.V.	3	3%
E.V., VAN	1	1%
STANDARD	45	41%
STANDARD, TANDOM	2	2%
Grand Total	109	100%

GROSS OPEN SPACE SCHEDULE	
Level	Area
COURTYARD	14170 SF
LANDSCAPING	38027 SF
Grand Total	52197 SF

SITE PLAN KEY	
---	PROPERTY LINE
---	FEMA FLOODPLAIN
---	CREEK SETBACK
---	PUBLIC ACCESS EASEMENT OUTLINE

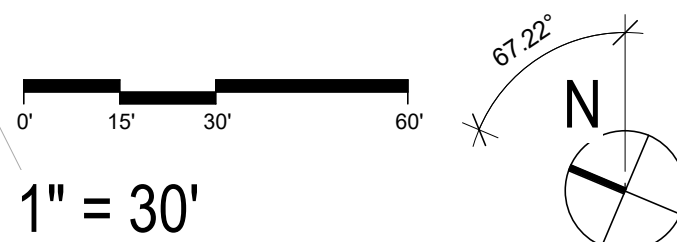

1/17/2020 5:16:09 PM

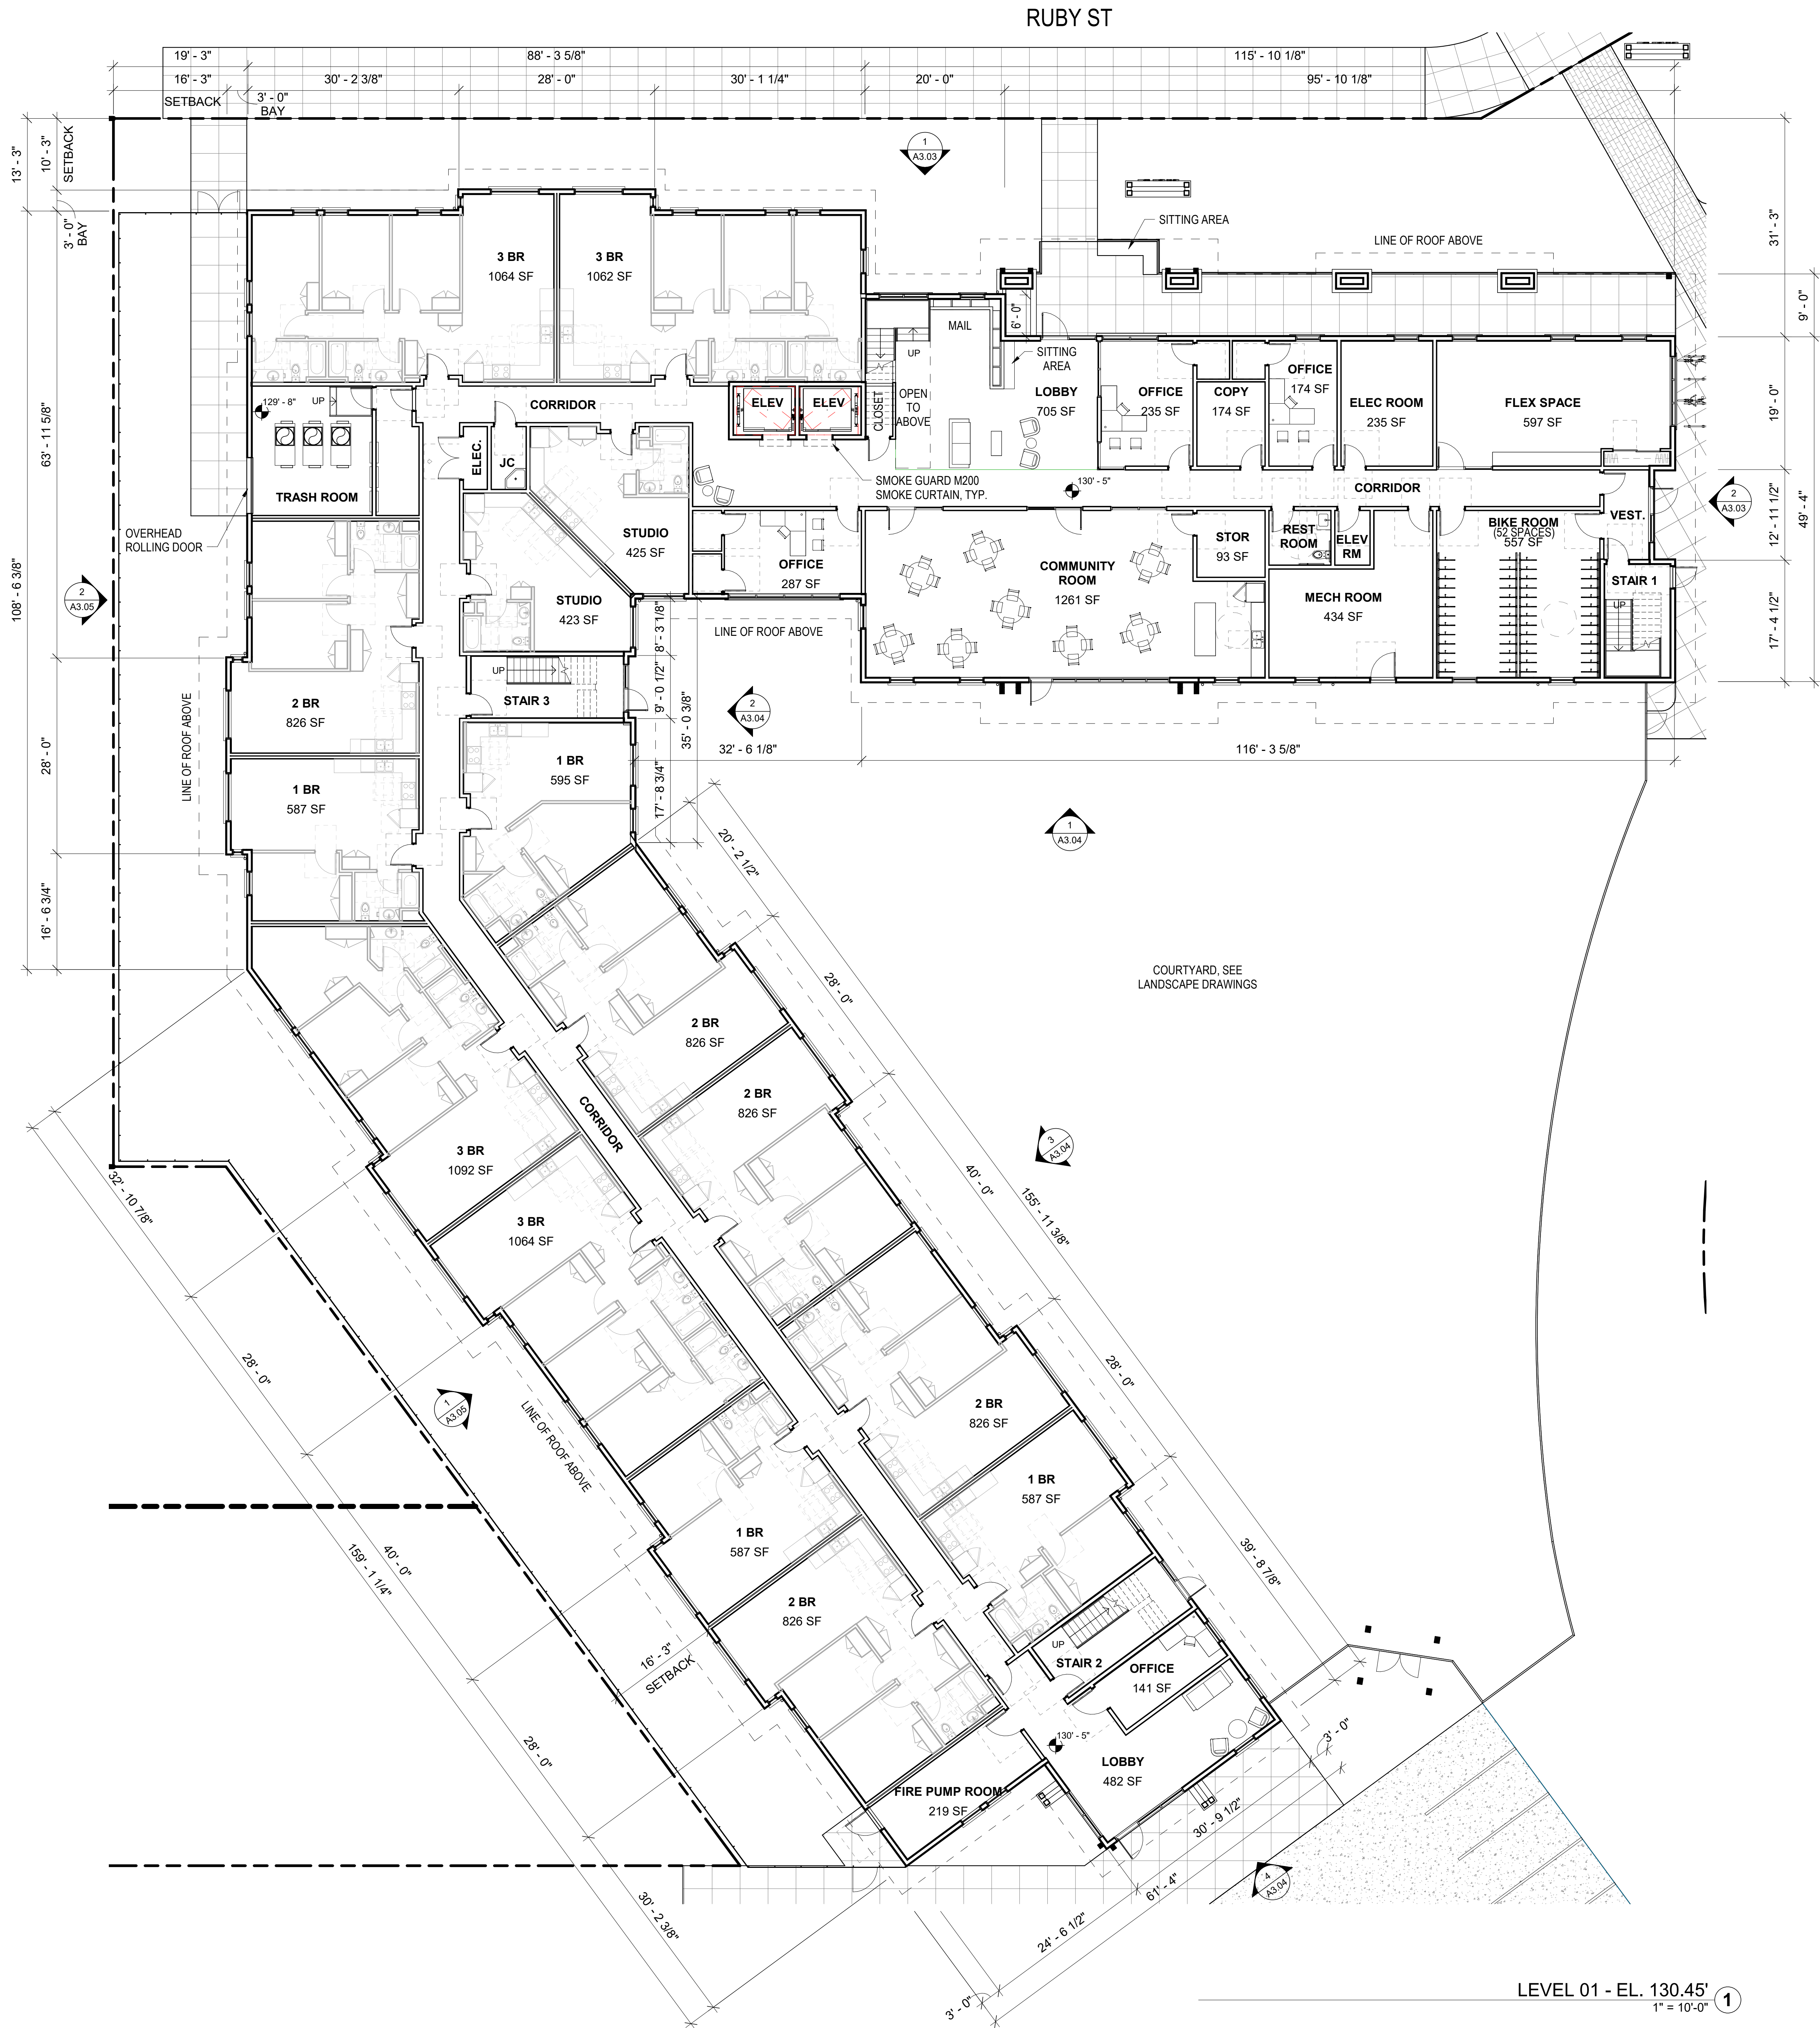

NOTES:

FIRE DEPARTMENT ACCESS KNOX BOXES WILL BE PROVIDED AT THE MAIN AND REAR ENTRY, AND AS DIRECTED BY THE FIRE DEPARTMENT

SHOWN LANDSCAPE PLAN IS CONCEPTUAL. PROPOSED TREES AND OTHER LANDSCAPE ELEMENTS WILL BE ADJUSTED TO COMPLY FULLY WITH CBC SEC. 1030 EMERGENCY ESCAPE AND RESCUE FOR ALL SLEEPING ROOM WINDOWS BELOW THE FOURTH STORY

UNIT COUNT BY FLOOR	
Name	Count
Level 1	
1 BR	4
2 BR	5
3 BR	4
STUDIO	2
15	

Level 2	
1 BR	10
2 BR	5
3 BR	6
STUDIO	2
23	


Level 3	
1 BR	9
2 BR	6
3 BR	4
STUDIO	2
21	

Level 4	
1 BR	4
2 BR	2
3 BR	5
STUDIO	2
13	
Grand Total	72

DWELLING UNIT MIX		
Unit Type	Count	Percentage
1 BR	27	38%
2 BR	18	25%
3 BR	19	26%
STUDIO	8	11%
Grand Total	72	100%

GROSS BUILDING AREA SCHEDULE	
Level	Area
LEVEL 01	22381 SF
LEVEL 02	22868 SF
LEVEL 03	20916 SF
LEVEL 04	13752 SF
Grand Total	79917 SF

0' 5' 10' 20'
1" = 10'

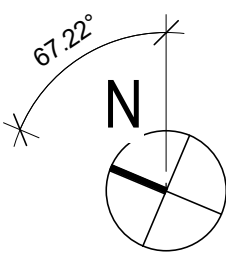

EDEN HOUSING

22845 Grand St, Hayward, CA 94541
(510) 582-1460

RUBY ST
Ruby St, Castro Valley, CA 94546

STAMP:


REVISION SCHEDULE
NO. | ISSUE | DATE

JOB NUMBER: 1744
DRAWN BY: KJ
CHECKED BY: CC
DATE: 01/27/2020
SCALE: 1" = 10'-0"
TITLE:

LEVLE 01 FLOOR PLAN

SHEET:

A2.01

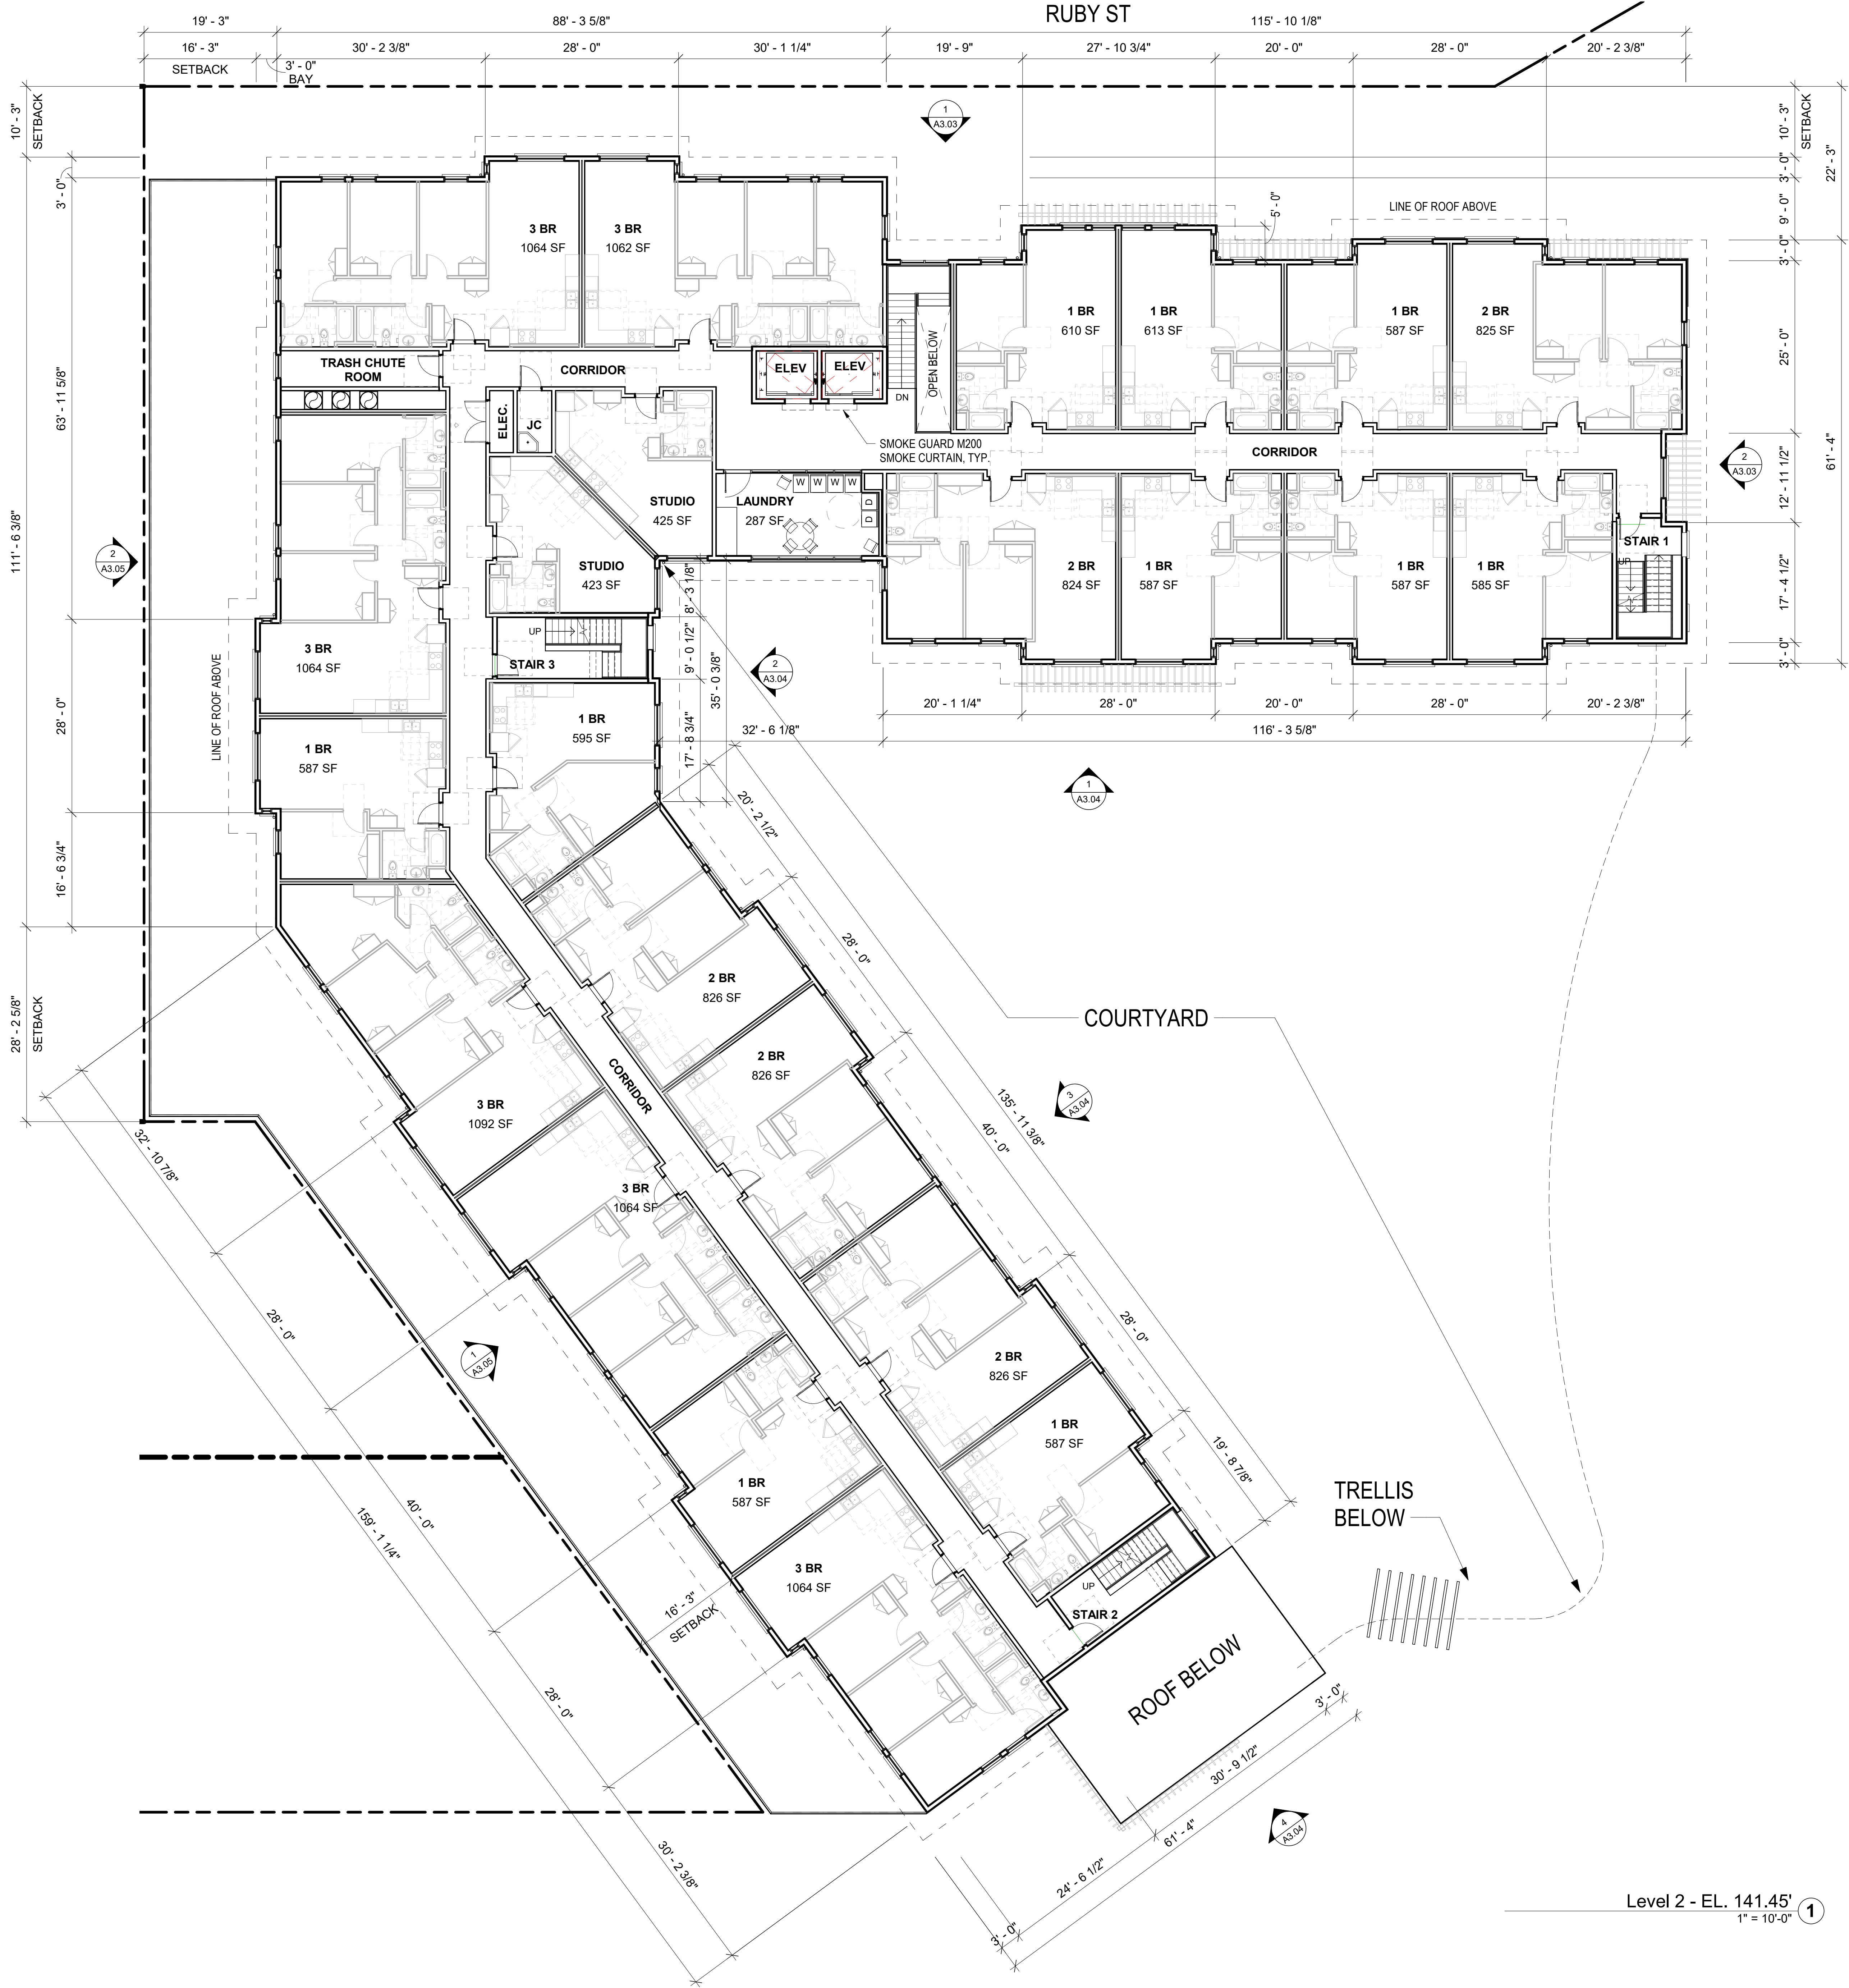

UNIT COUNT BY FLOOR	
Name	Count
Level 1	
1 BR	4
2 BR	5
3 BR	4
STUDIO	2
15	

Level 2	
1 BR	10
2 BR	5
3 BR	6
STUDIO	2
23	


Level 3	
1 BR	9
2 BR	6
3 BR	4
STUDIO	2
21	

Level 4	
1 BR	4
2 BR	2
3 BR	5
STUDIO	2
13	
Grand Total	72

DWELLING UNIT MIX		
Unit Type	Count	Percentage
1 BR	27	38%
2 BR	18	25%
3 BR	19	26%
STUDIO	8	11%
Grand Total	72	100%

GROSS BUILDING AREA SCHEDULE	
Level	Area
LEVEL 01	22381 SF
LEVEL 02	22868 SF
LEVEL 03	20916 SF
LEVEL 04	13752 SF
Grand Total	79917 SF


Level 2 - EL. 141.45' ①
1" = 10'-0"

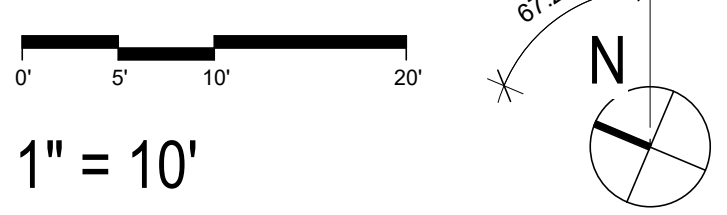

1/17/2020 5:16:35 PM



Level 3 - EL. 151.45' 1
1" = 10'-0"

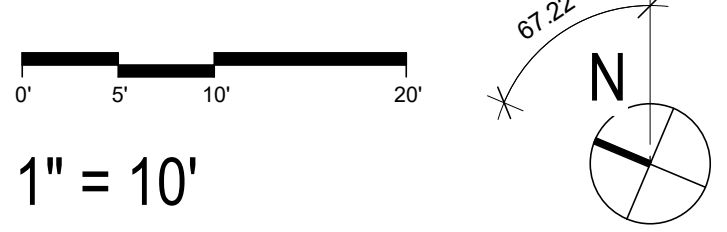

UNIT COUNT BY FLOOR	
Name	Count
Level 1	
1 BR	4
2 BR	5
3 BR	4
STUDIO	2
15	

Level 2	
1 BR	10
2 BR	5
3 BR	6
STUDIO	2
23	


Level 3	
1 BR	9
2 BR	6
3 BR	4
STUDIO	2
21	

Level 4	
1 BR	4
2 BR	2
3 BR	5
STUDIO	2
13	
Grand Total	72


DWELLING UNIT MIX		
Unit Type	Count	Percentage
1 BR	27	38%
2 BR	18	25%
3 BR	19	26%
STUDIO	8	11%
Grand Total	72	100%

GROSS BUILDING AREA SCHEDULE	
Level	Area
LEVEL 01	22381 SF
LEVEL 02	22868 SF
LEVEL 03	20916 SF
LEVEL 04	13752 SF
Grand Total	79917 SF

1/17/2020 5:16:47 PM

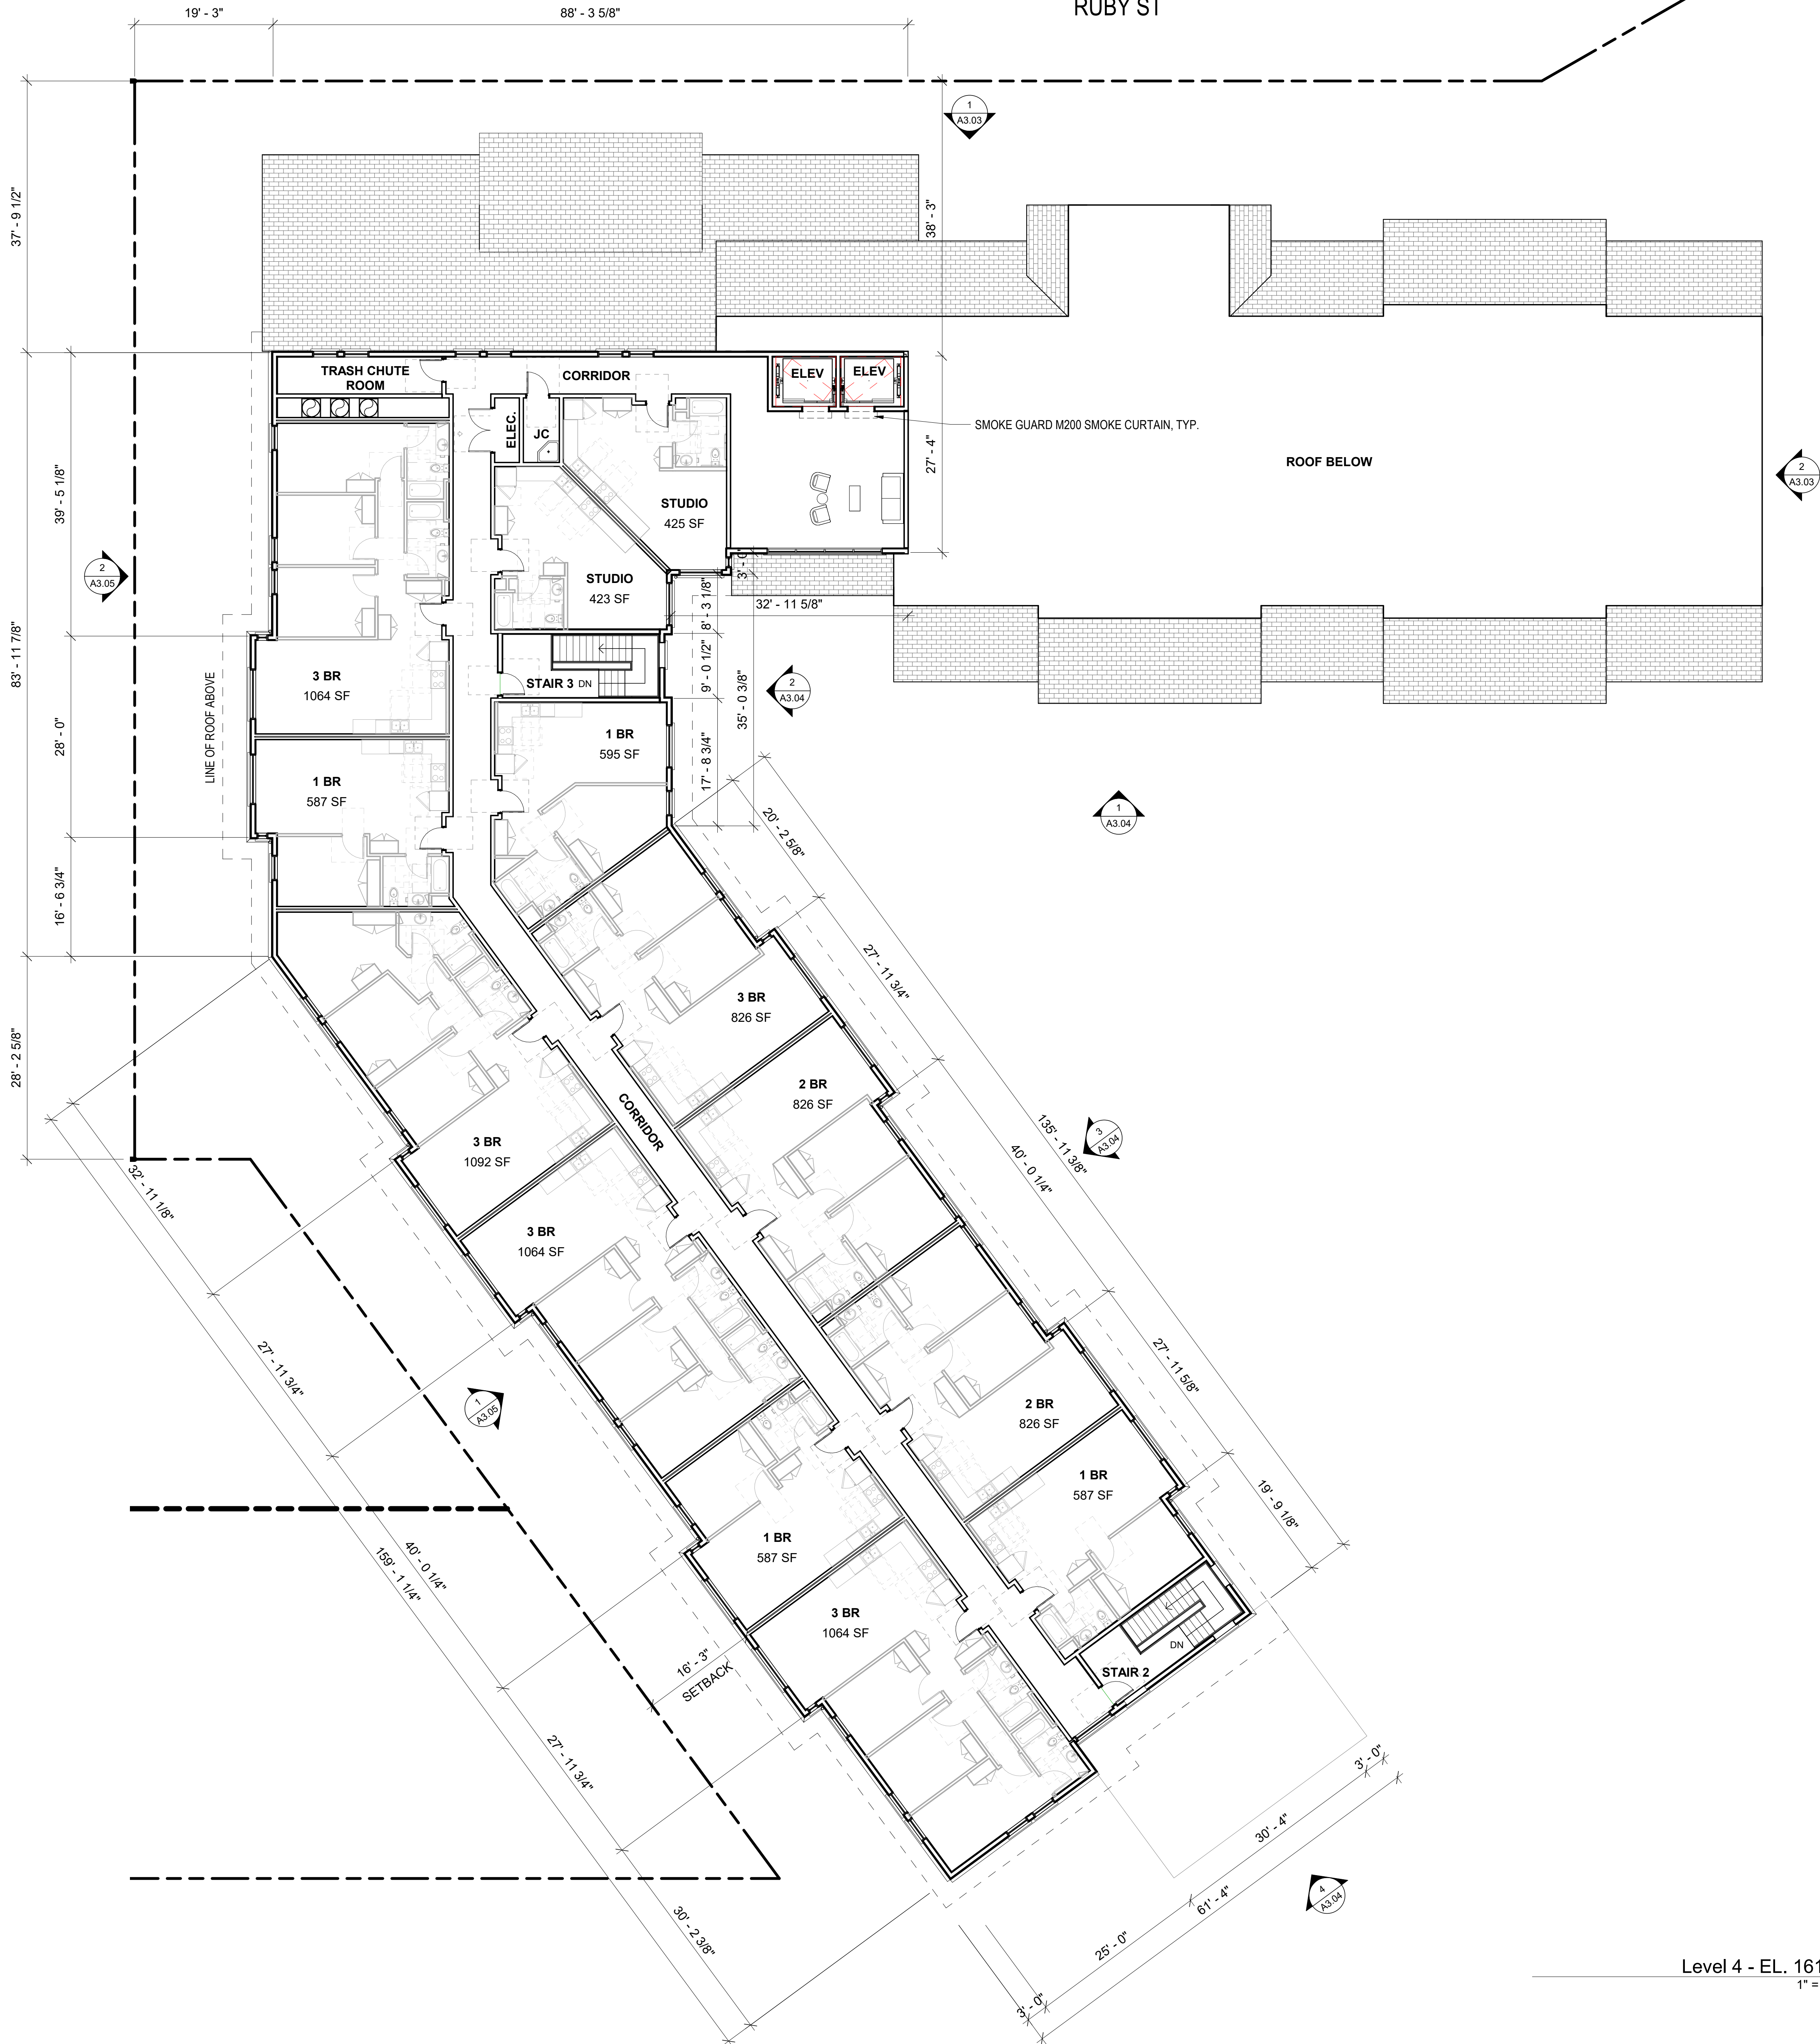

Level 4 - EL. 161.45' 1
1" = 10'-0"

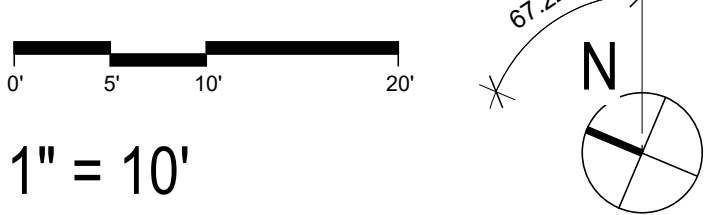

UNIT COUNT BY FLOOR	
Name	Count
Level 1	
1 BR	4
2 BR	5
3 BR	4
STUDIO	2
15	
Level 2	
1 BR	10
2 BR	5
3 BR	6
STUDIO	2
23	
Level 3	
1 BR	9
2 BR	6
3 BR	4
STUDIO	2
21	
Level 4	
1 BR	4
2 BR	2
3 BR	5
STUDIO	2
13	
Grand Total	72

DWELLING UNIT MIX		
Unit Type	Count	Percentage
1 BR	27	38%
2 BR	18	25%
3 BR	19	26%
STUDIO	8	11%
Grand Total	72	100%

GROSS BUILDING AREA SCHEDULE	
Level	Area
LEVEL 01	22381 SF
LEVEL 02	22868 SF
LEVEL 03	20916 SF
LEVEL 04	13752 SF
Grand Total	79917 SF

1/17/2020 5:16:50 PM



UNIT COUNT BY FLOOR	
Name	Count
Level 1	
1 BR	4
2 BR	5
3 BR	4
STUDIO	2
15	

Level 2	
1 BR	10
2 BR	5
3 BR	6
STUDIO	2
23	

Level 3	
1 BR	9
2 BR	6
3 BR	4
STUDIO	2
21	

Level 4	
1 BR	4
2 BR	2
3 BR	5
STUDIO	2
13	
Grand Total	72

DWELLING UNIT MIX		
Unit Type	Count	Percentage
1 BR	27	38%
2 BR	18	25%
3 BR	19	26%
STUDIO	8	11%
Grand Total	72	100%

GROSS BUILDING AREA SCHEDULE	
Level	Area
LEVEL 01	22381 SF
LEVEL 02	22868 SF
LEVEL 03	20916 SF
LEVEL 04	13752 SF
Grand Total	79917 SF



REAR COURTYARD VIEW



RUBY STREET FACADE VIEW



DIMENSIONAL COMPOSITION SHINGLES
GRAY



FIBER CEMENT BOARD SHINGLE

WEATHERED
BROWN
DE C756




RIVER ROCKS
DE 6061



DESERT ROCK
DE 6066




**VERTICAL CEMENT BOARD SIDING
BOARD-AND-BATTEN**
SPIRIT MOUNTAIN
DE 5795

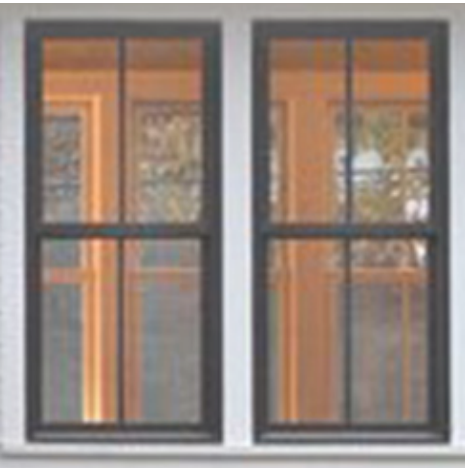

VINYL WINDOW
DARK BRONZE



SILL
WANDERING ROAD
DE 6076

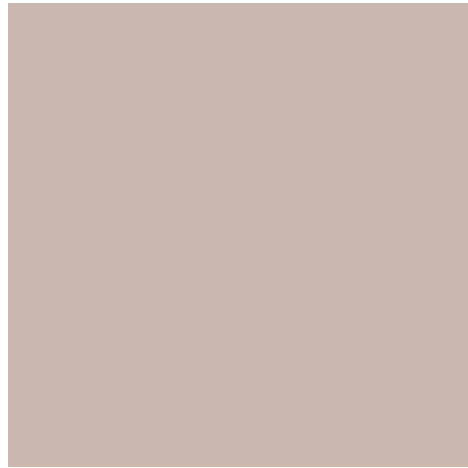


SILL / FASCIA
FRONTIER LAND
DE 6074




WOOD




CULTURED STONE VENEER

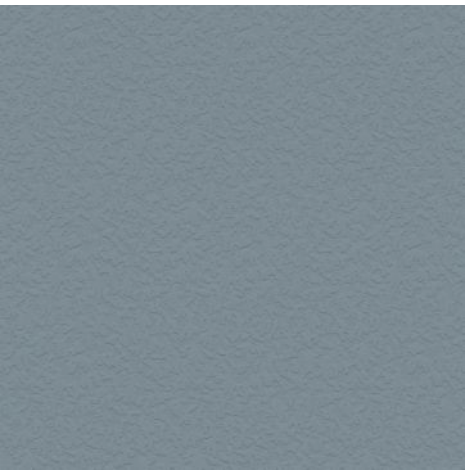


STUCCO BASE
BLUE MONDAY
DE T568

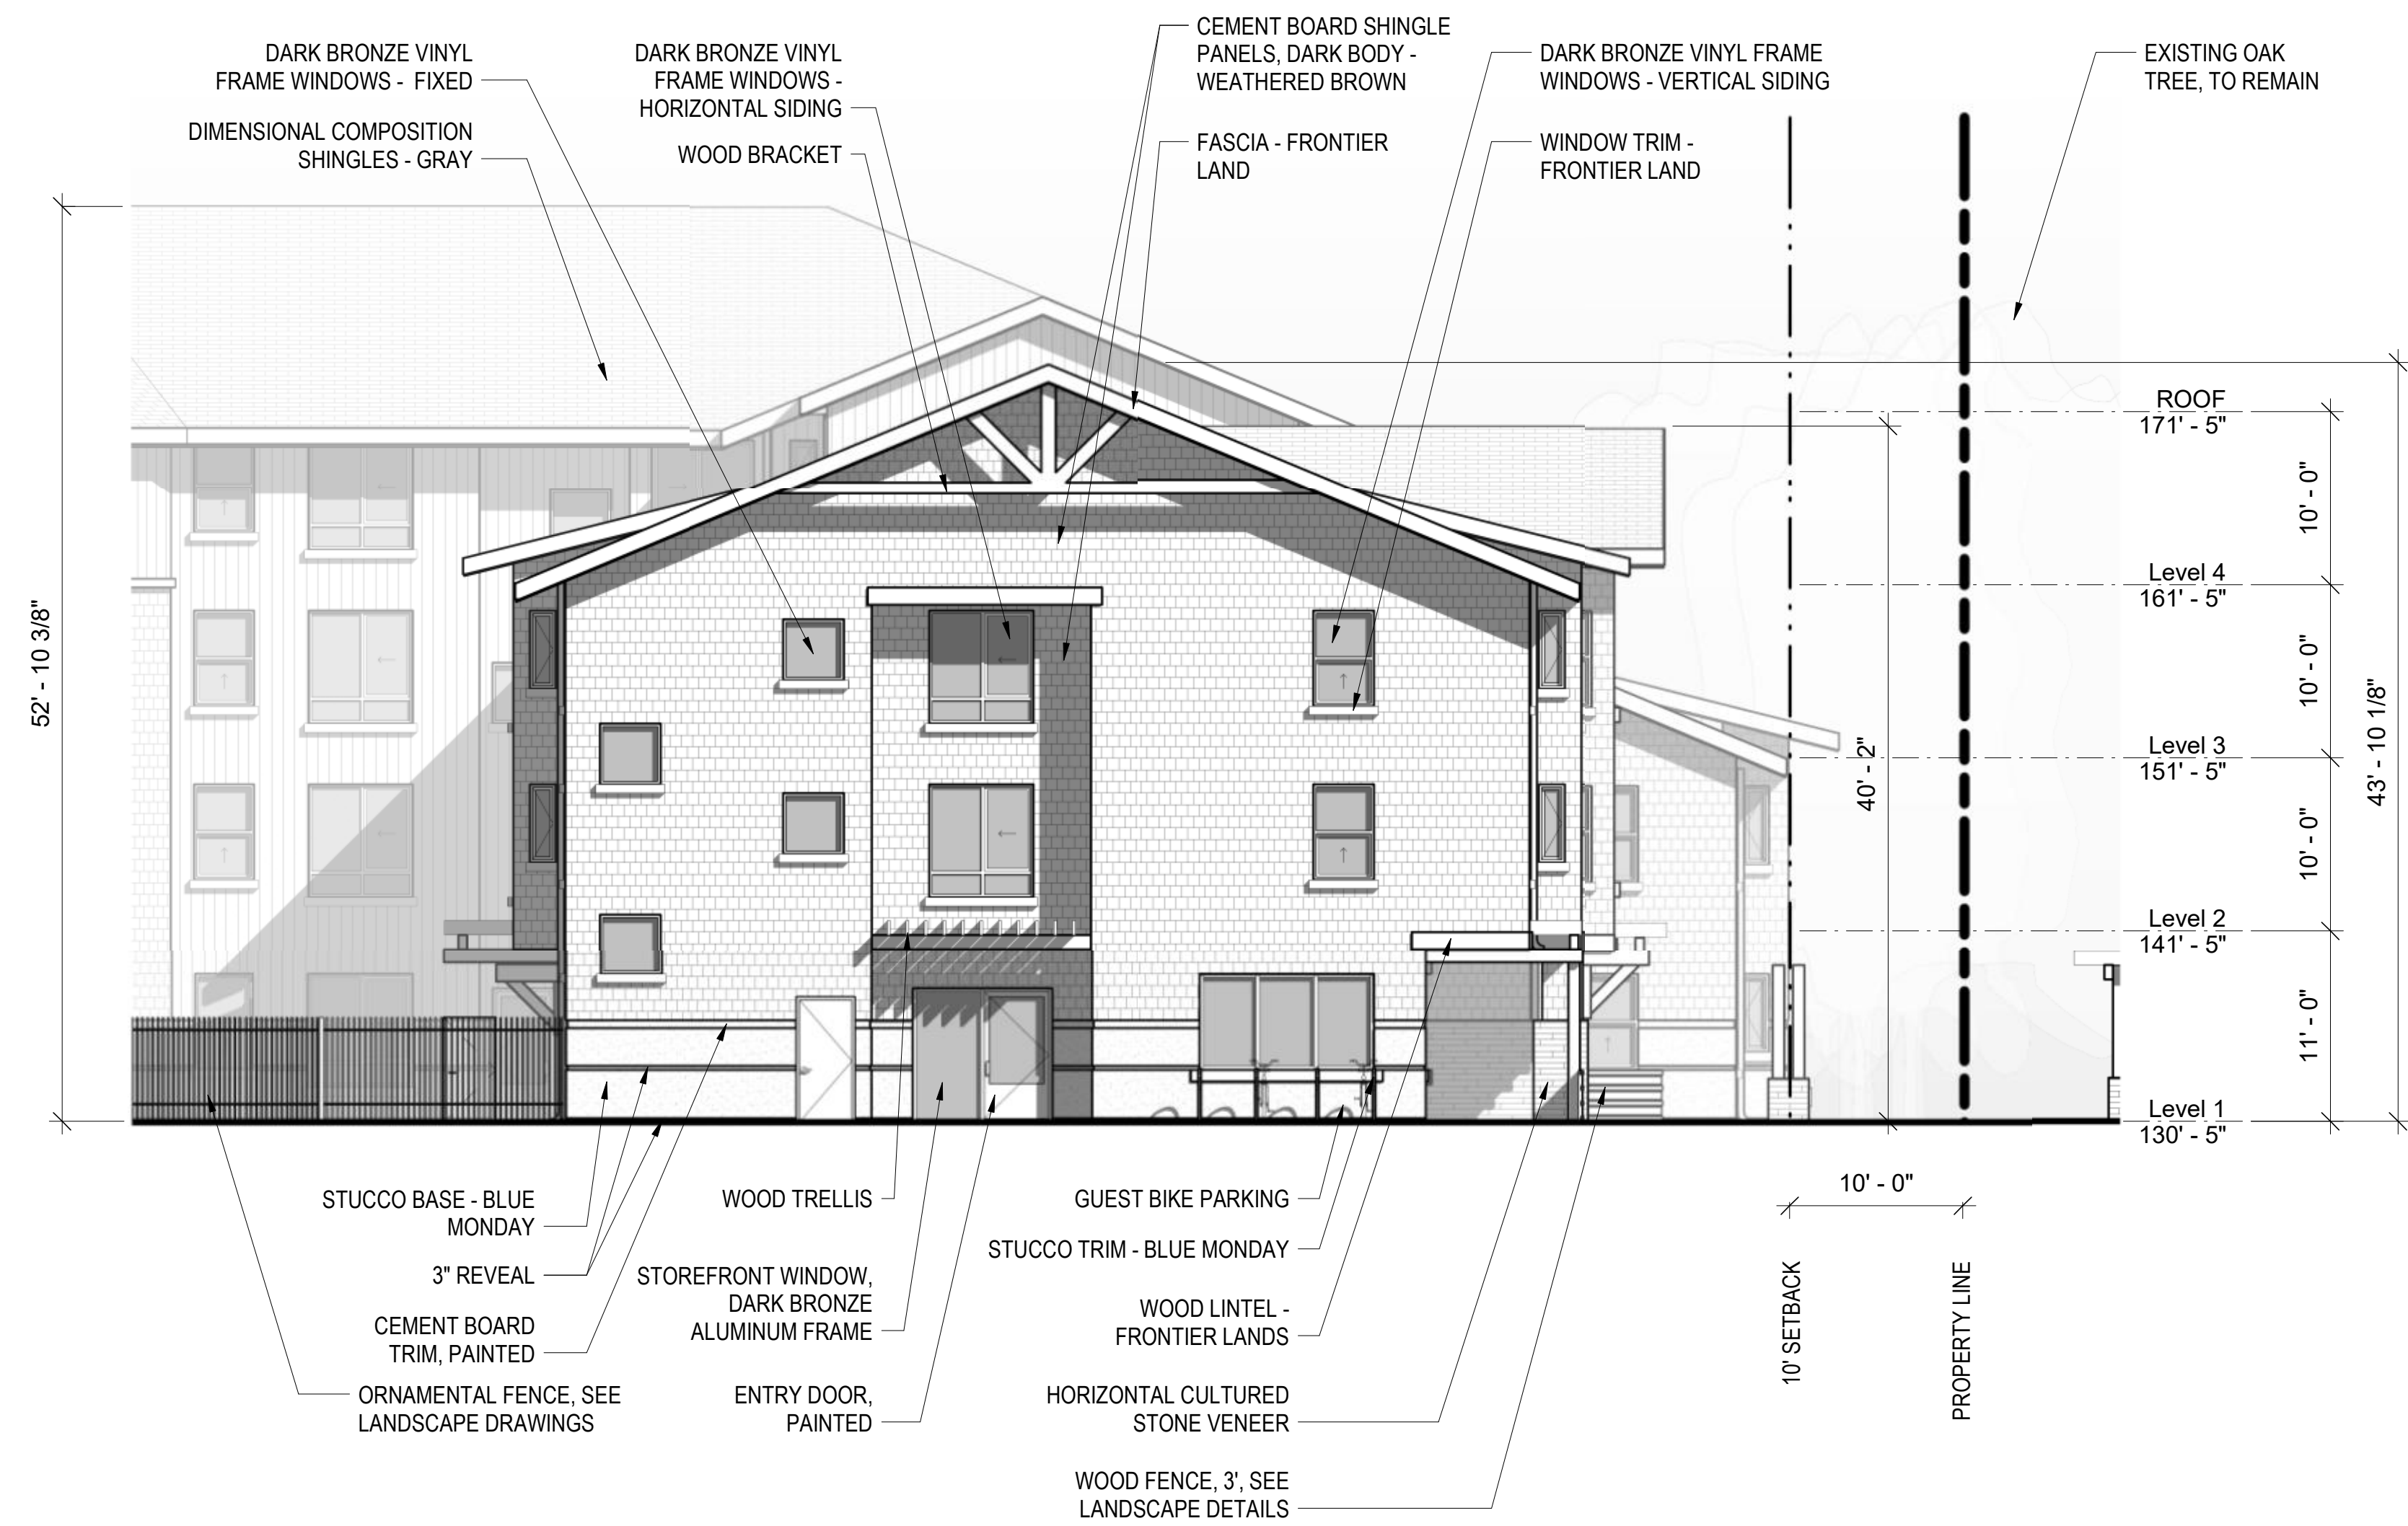

South Elevation_Ruby St Lot 2
1/8" = 1'-0"

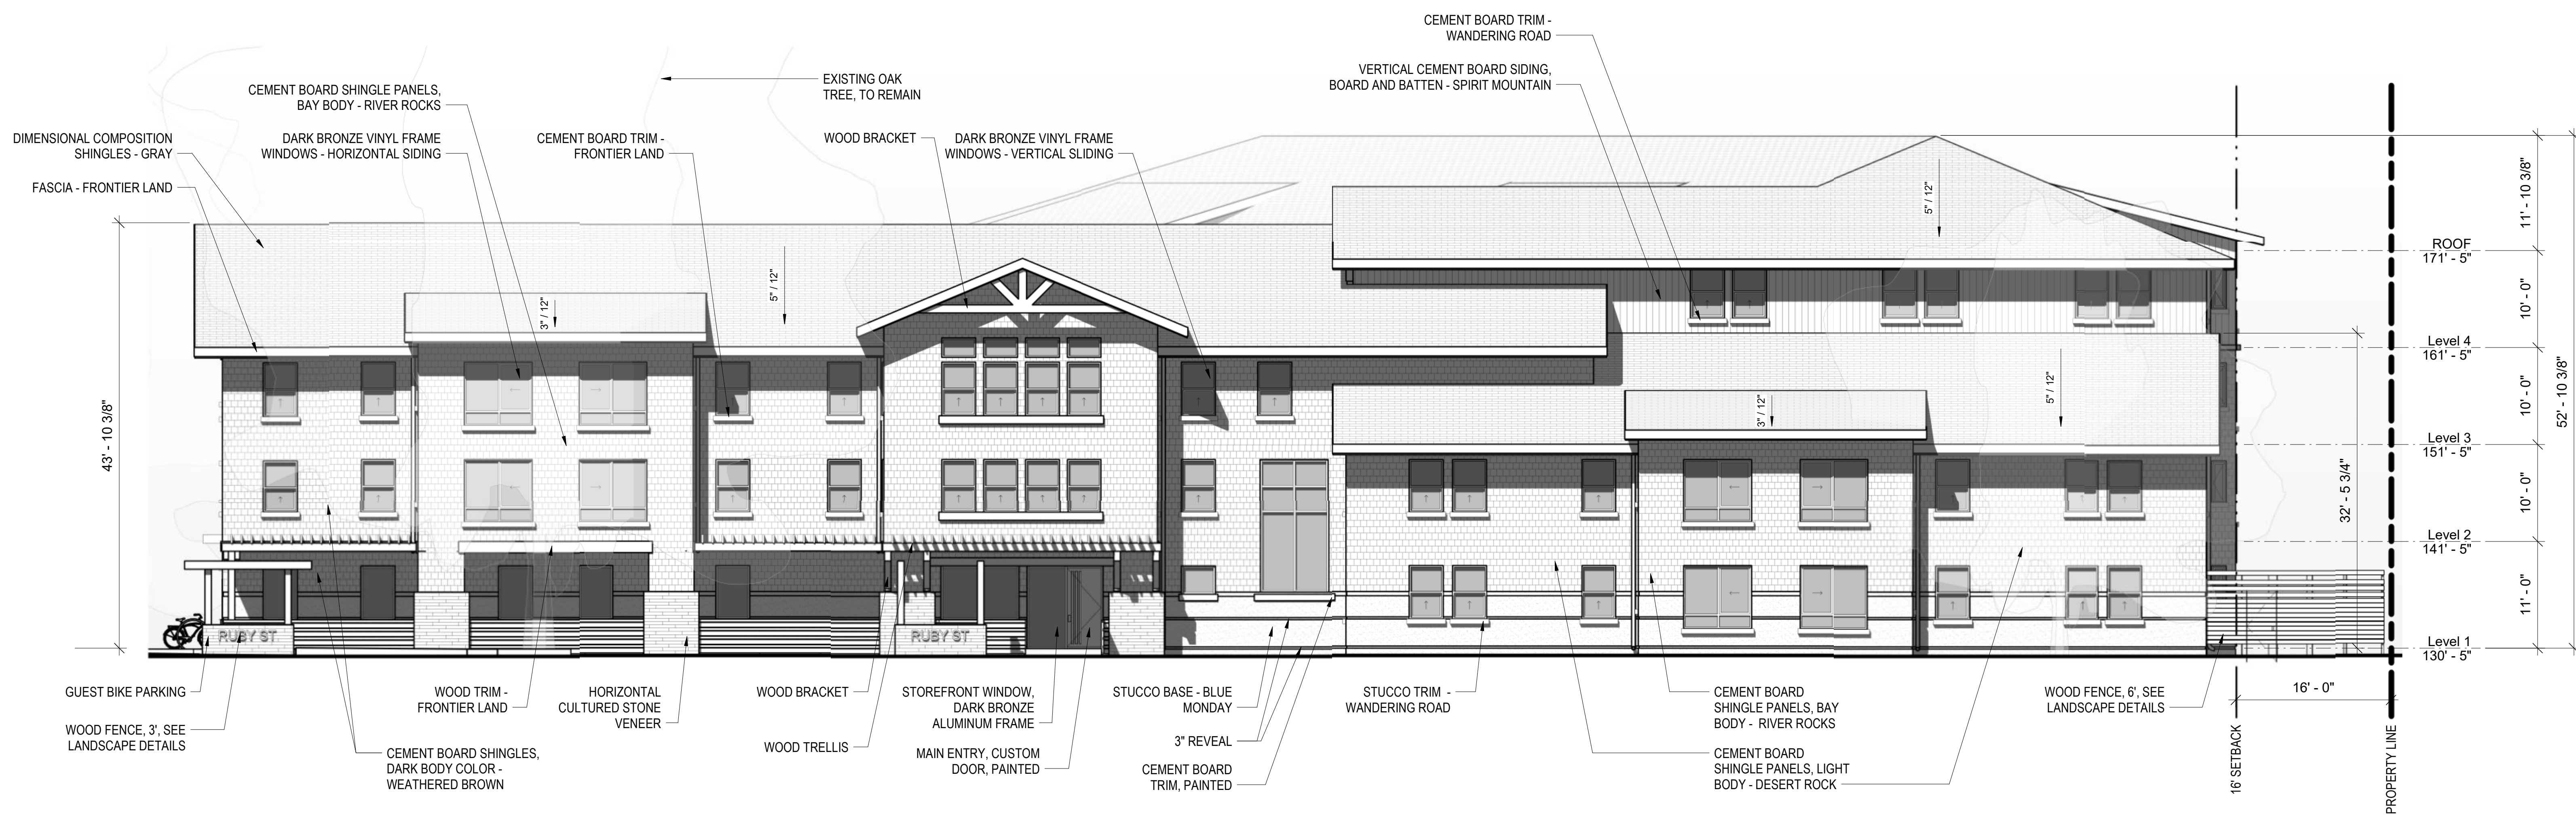


East Elevation_Ruby St 1
1/8" = 1'-0"

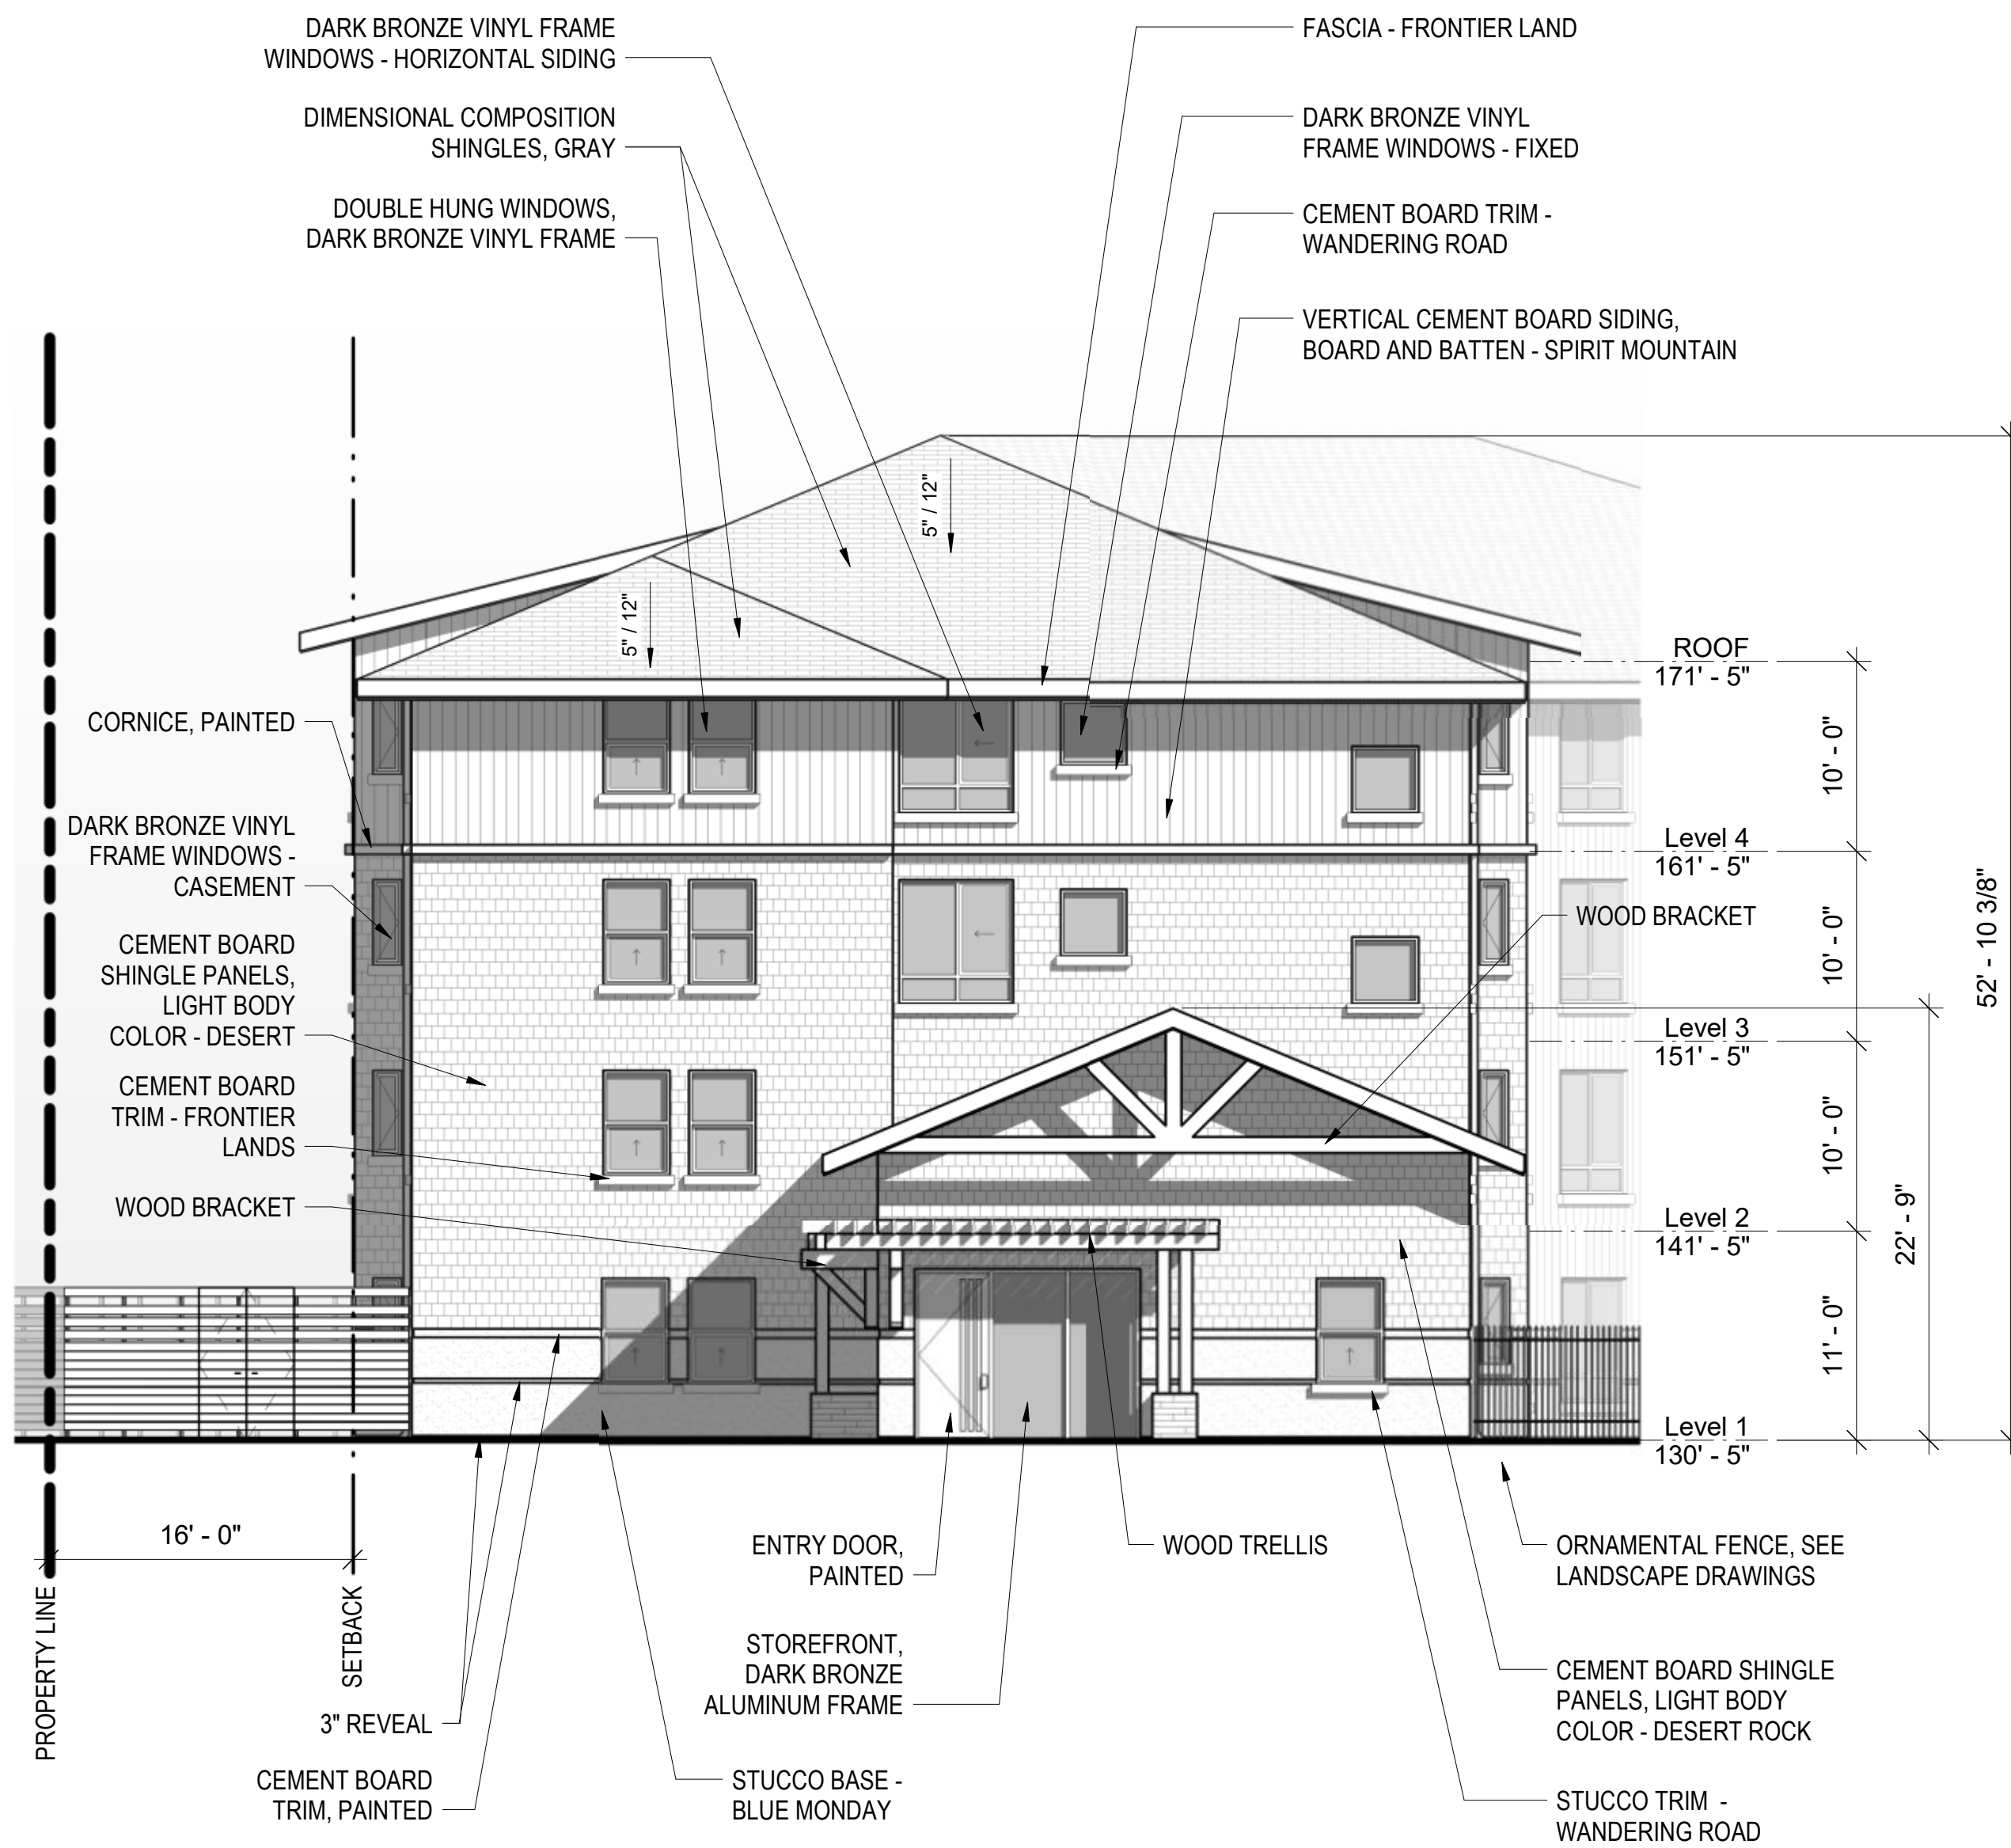


South West Elevation_Crescent St Lot ④
1/8" = 1'-0"




South East Elevation_Courtyard ③
1/8" = 1'-0"

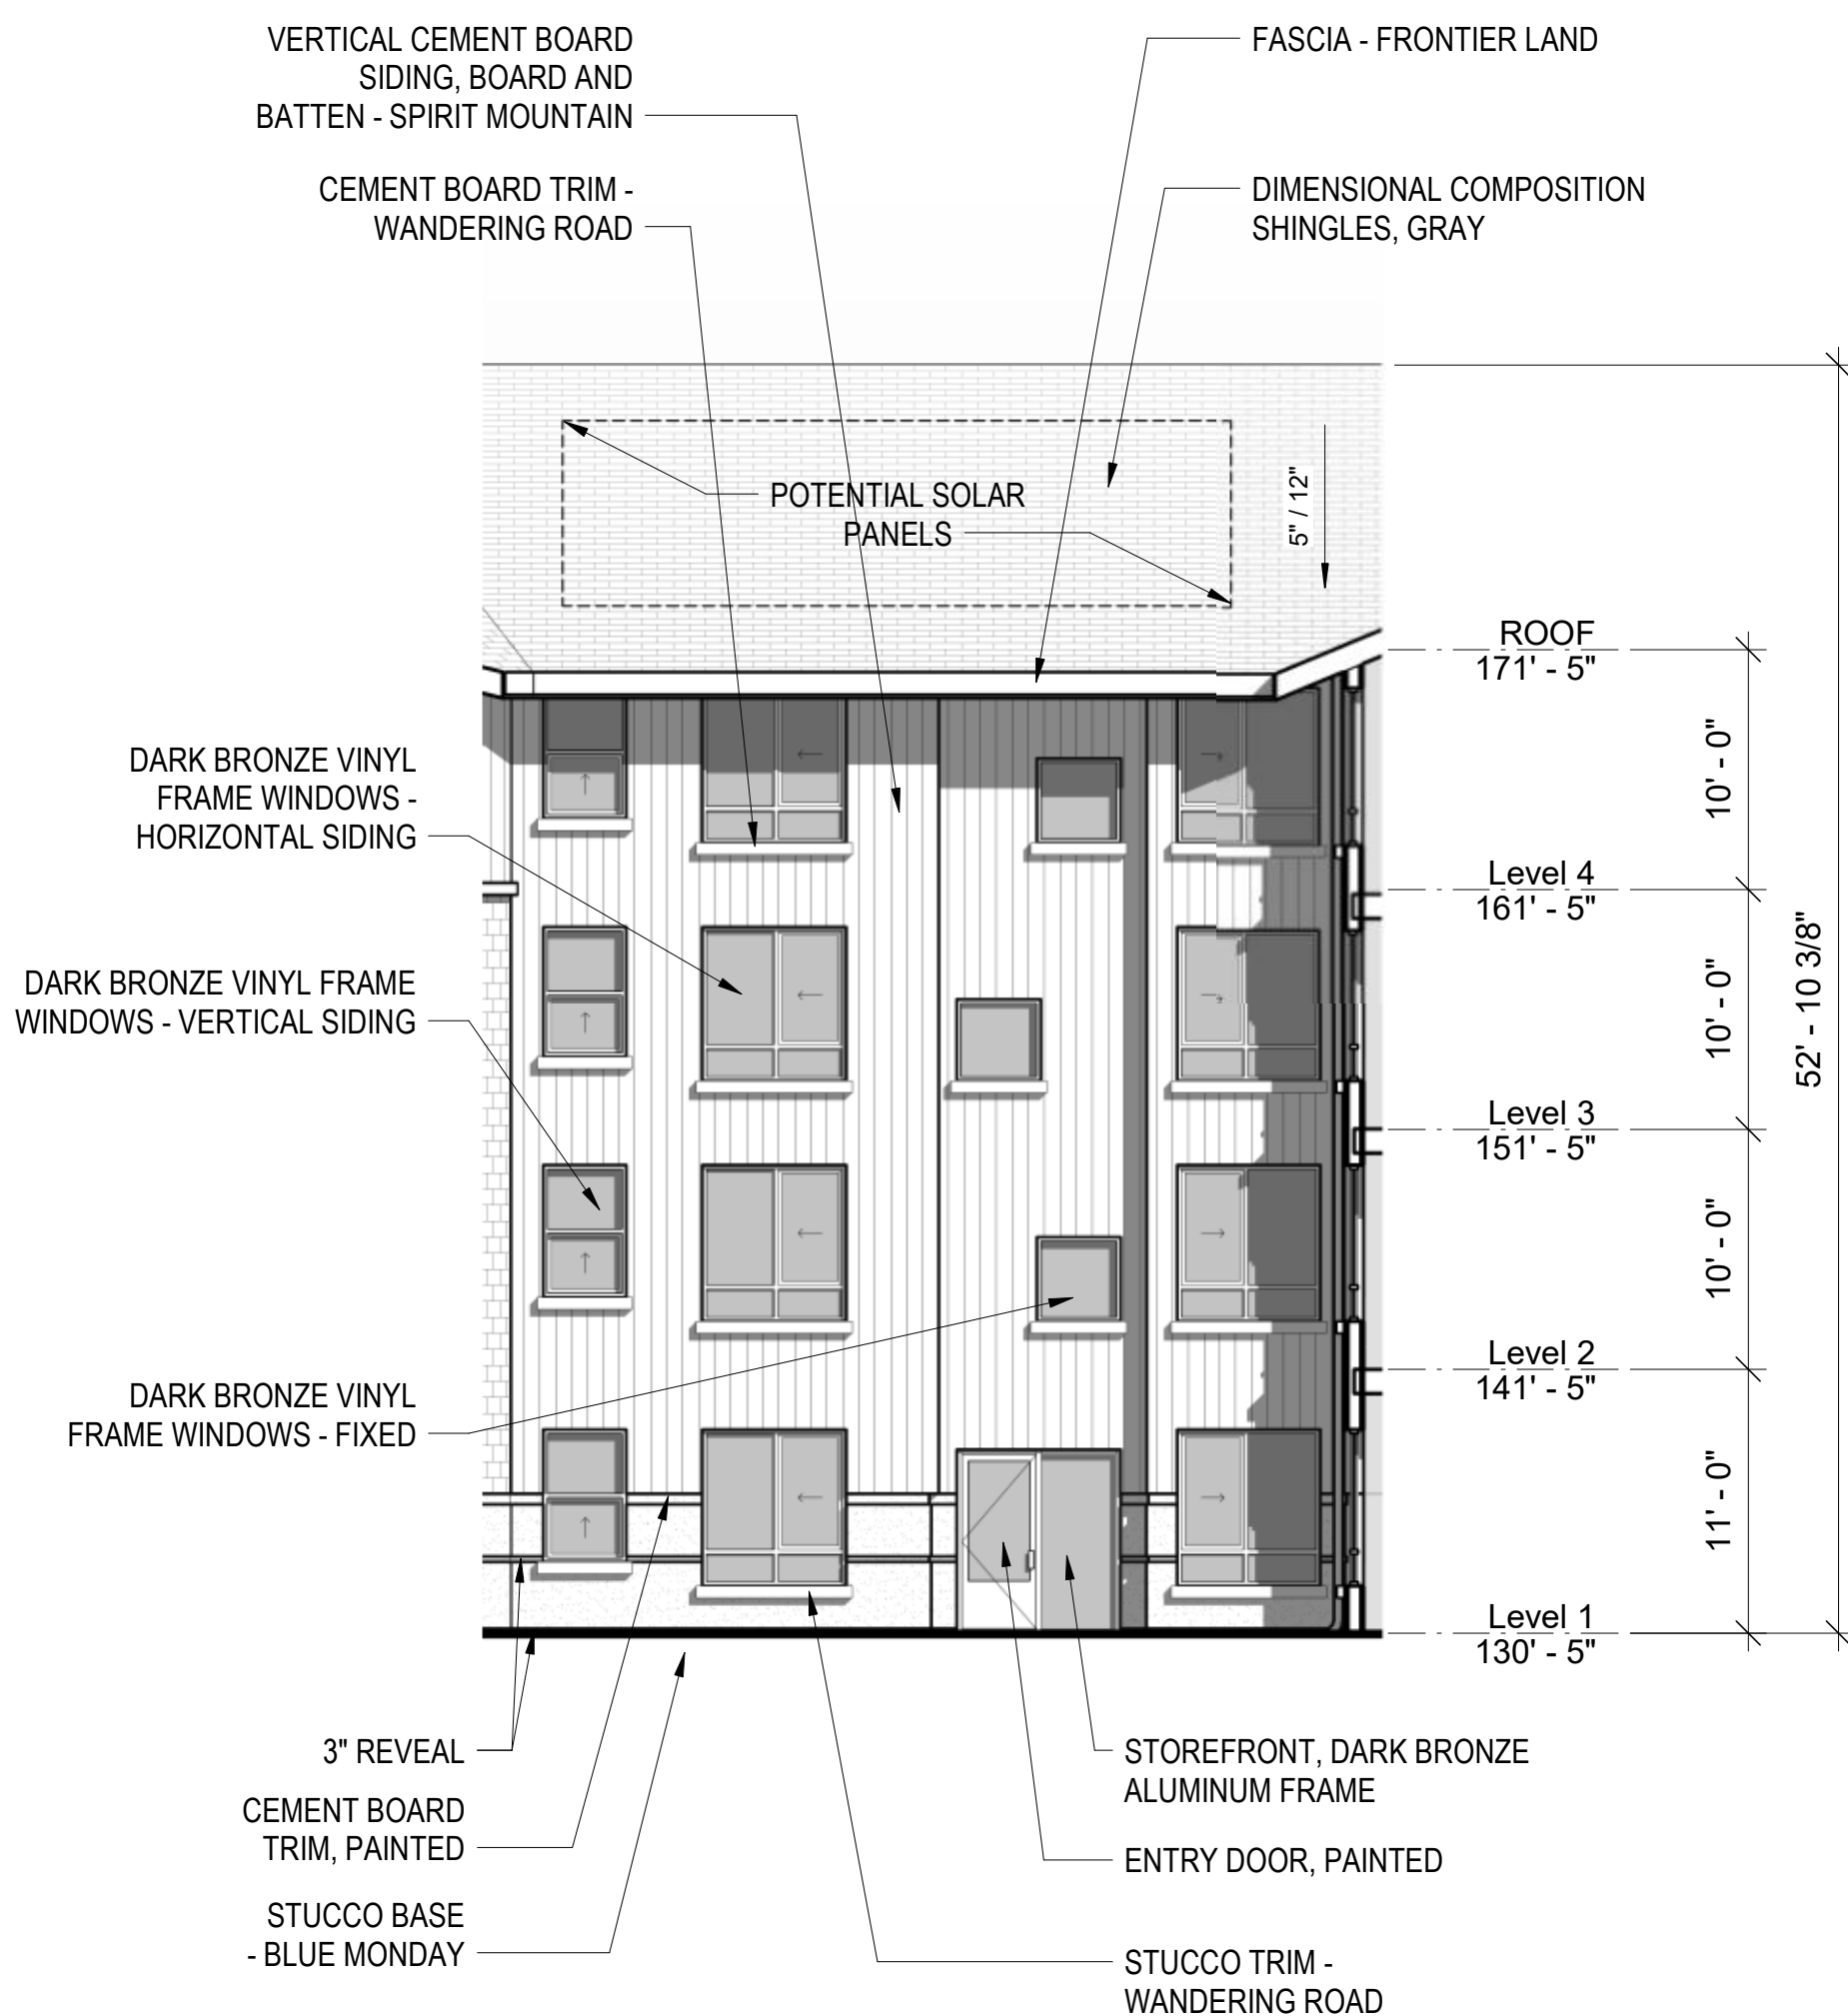


South Elevation_Courtyard ②
1/8" = 1'-0"

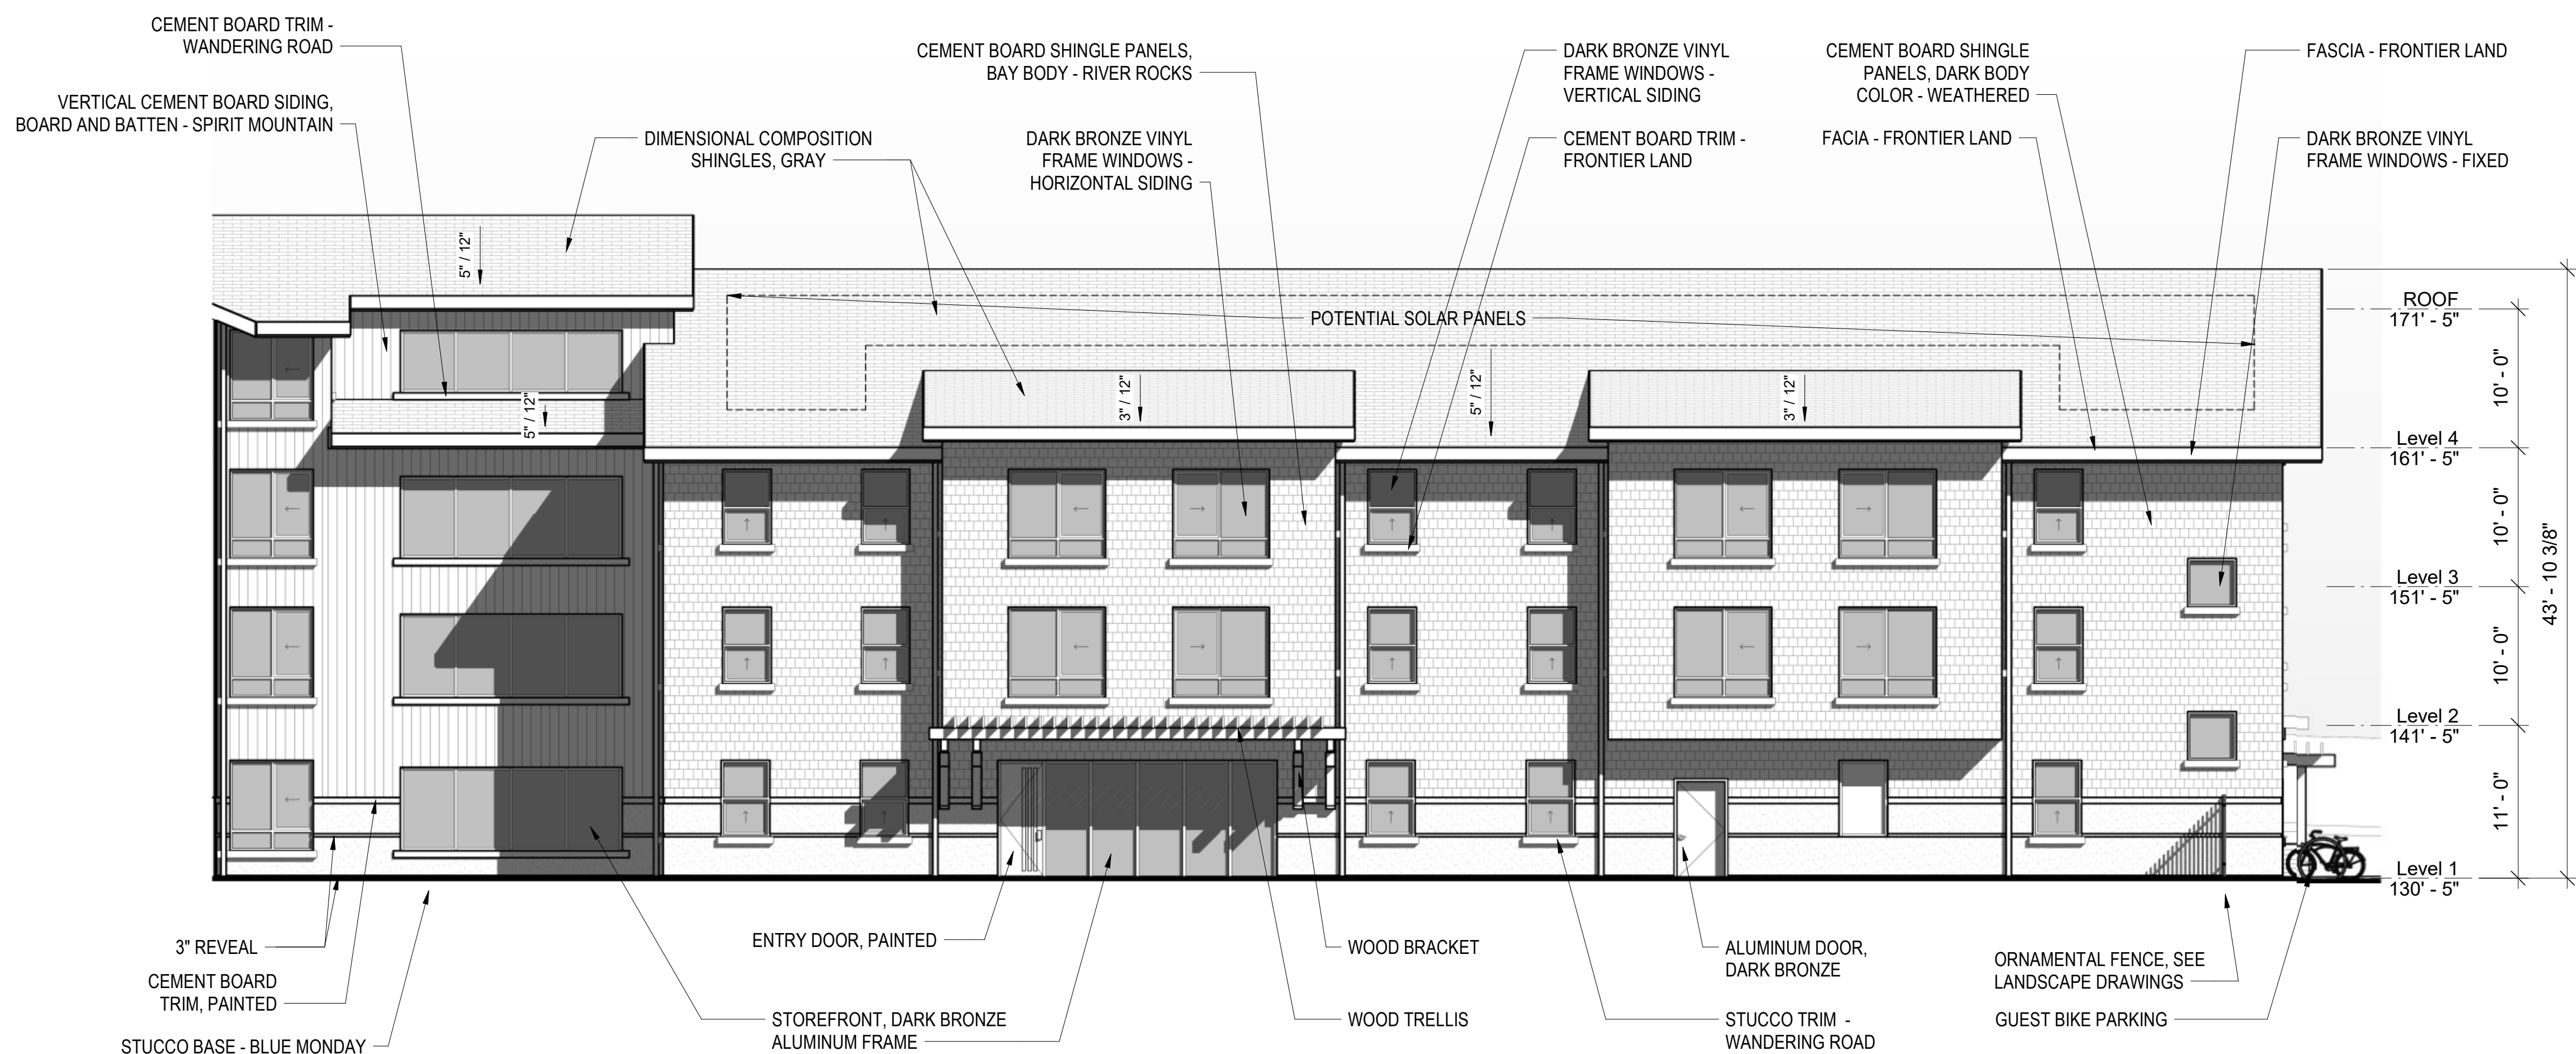

West Elevation_Courtyard ①
1/8" = 1'-0"

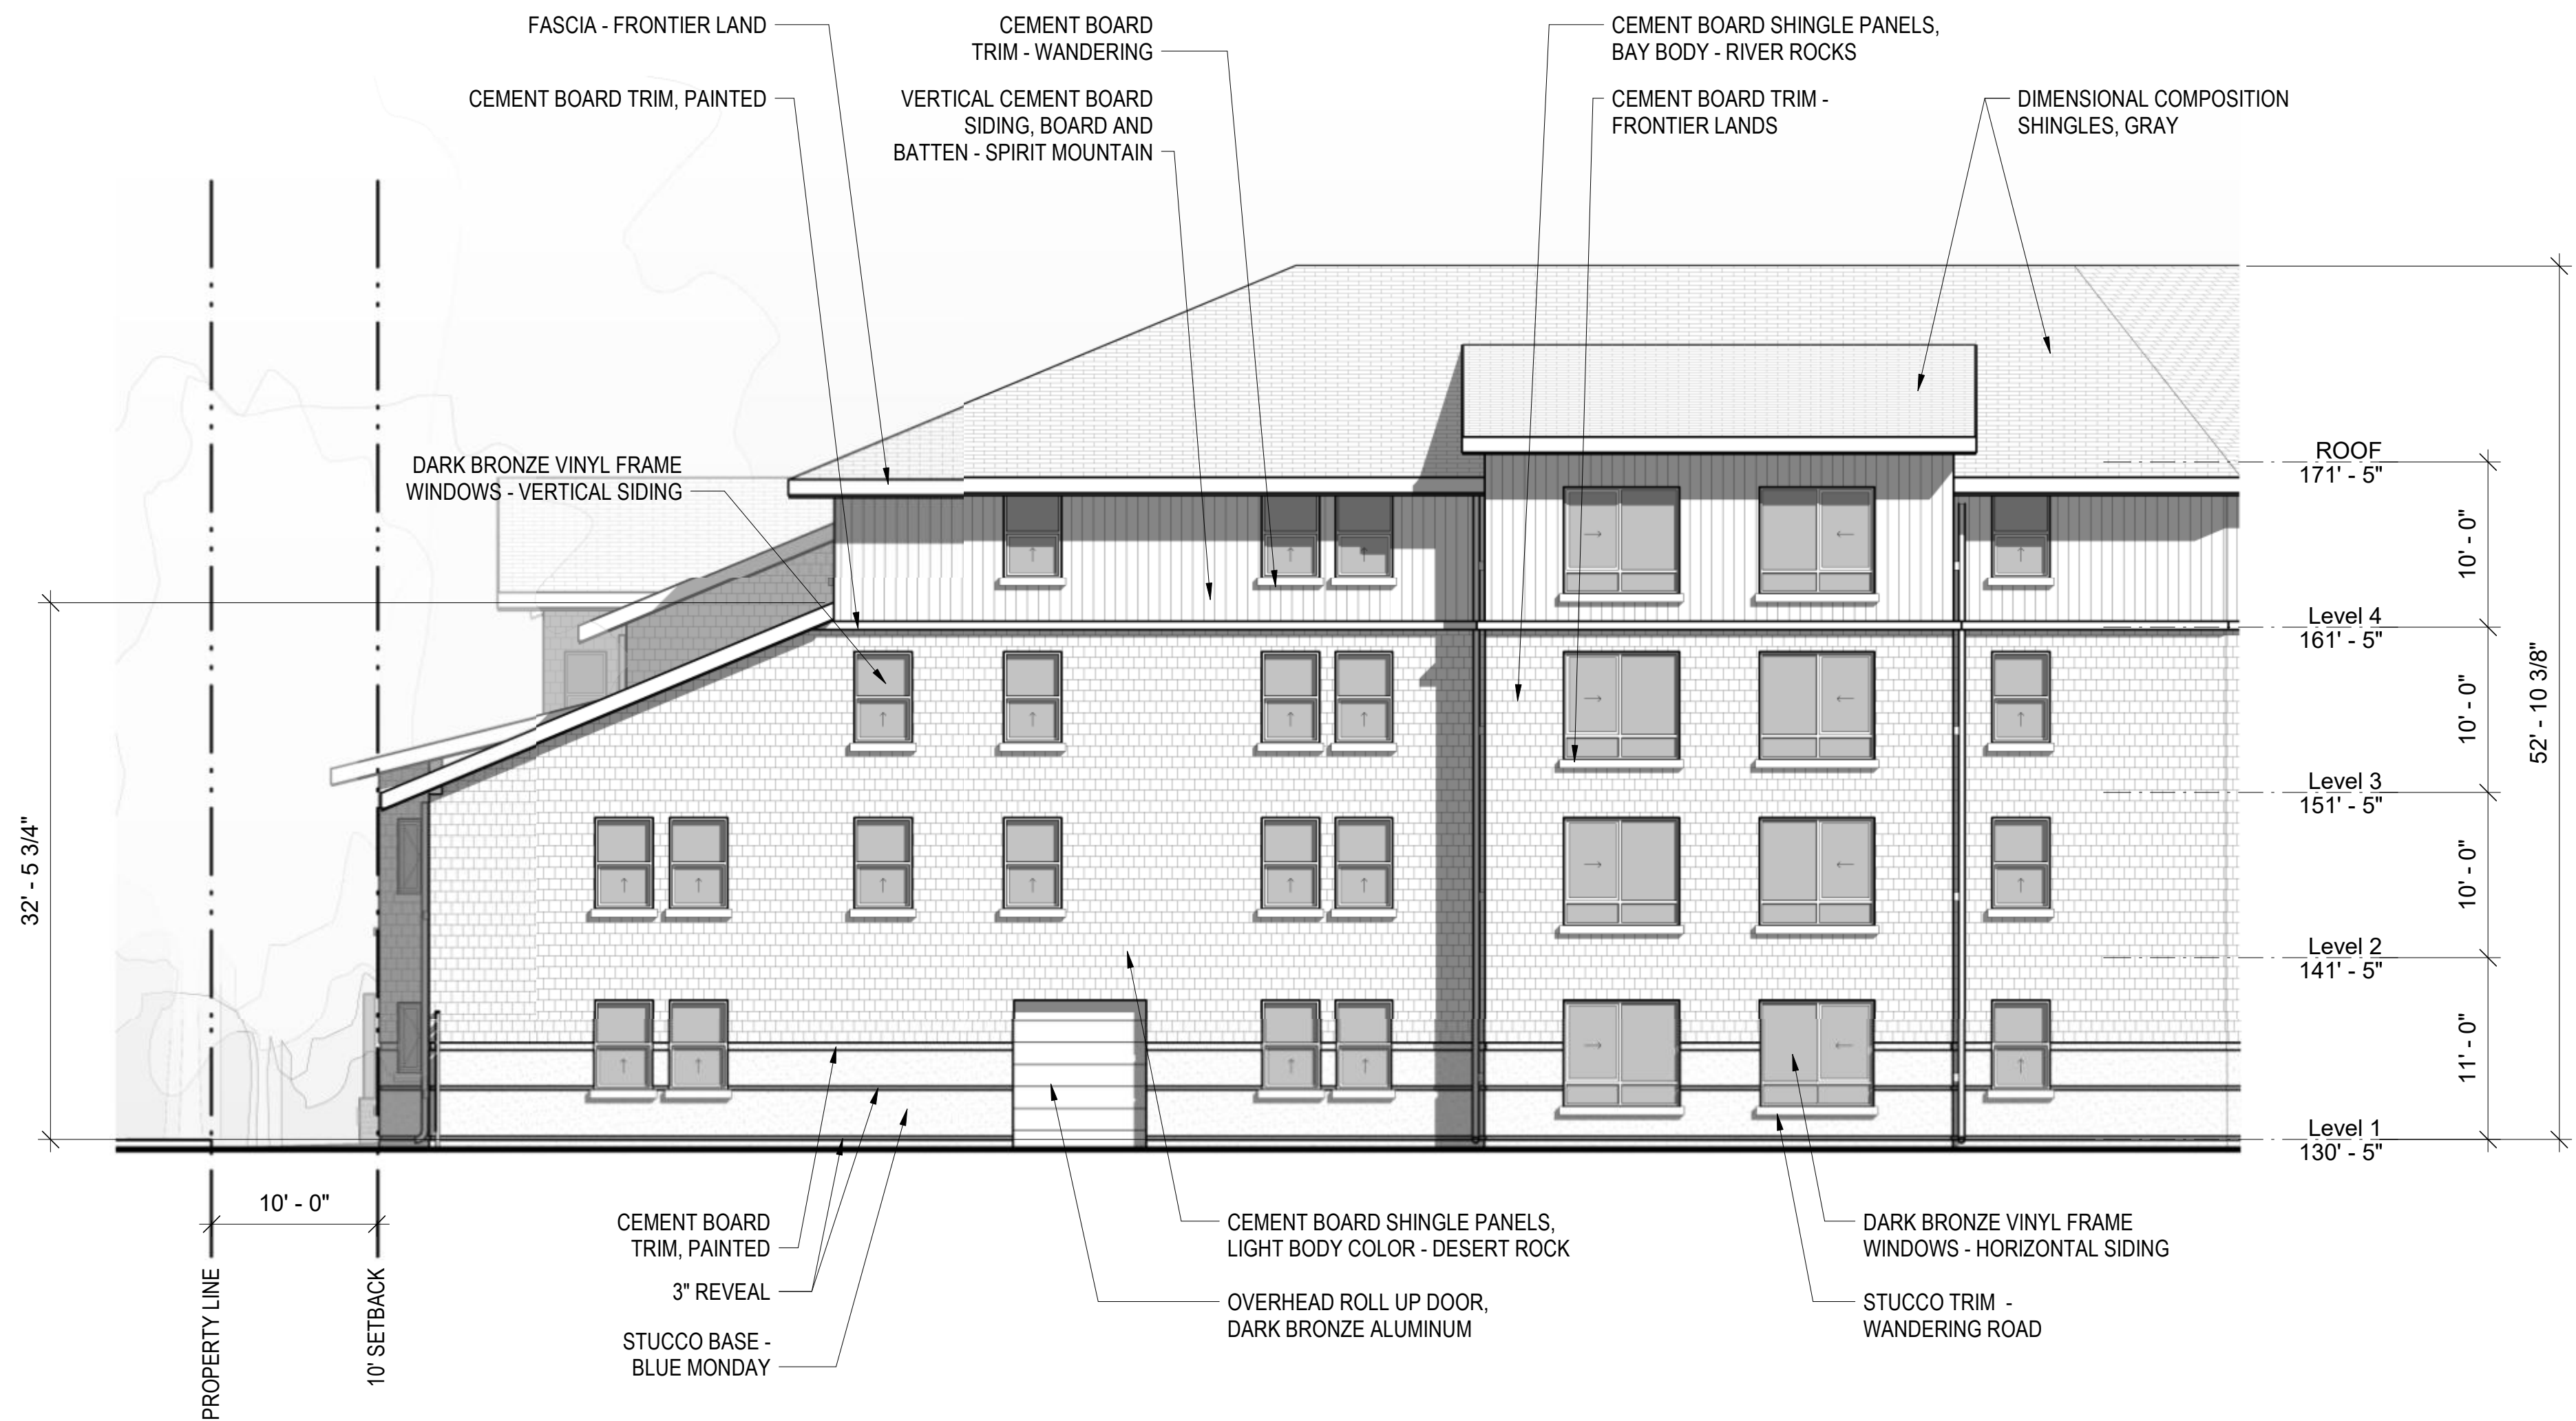

North Elevation_ Interior Lot Line ②
1/8" = 1'-0"

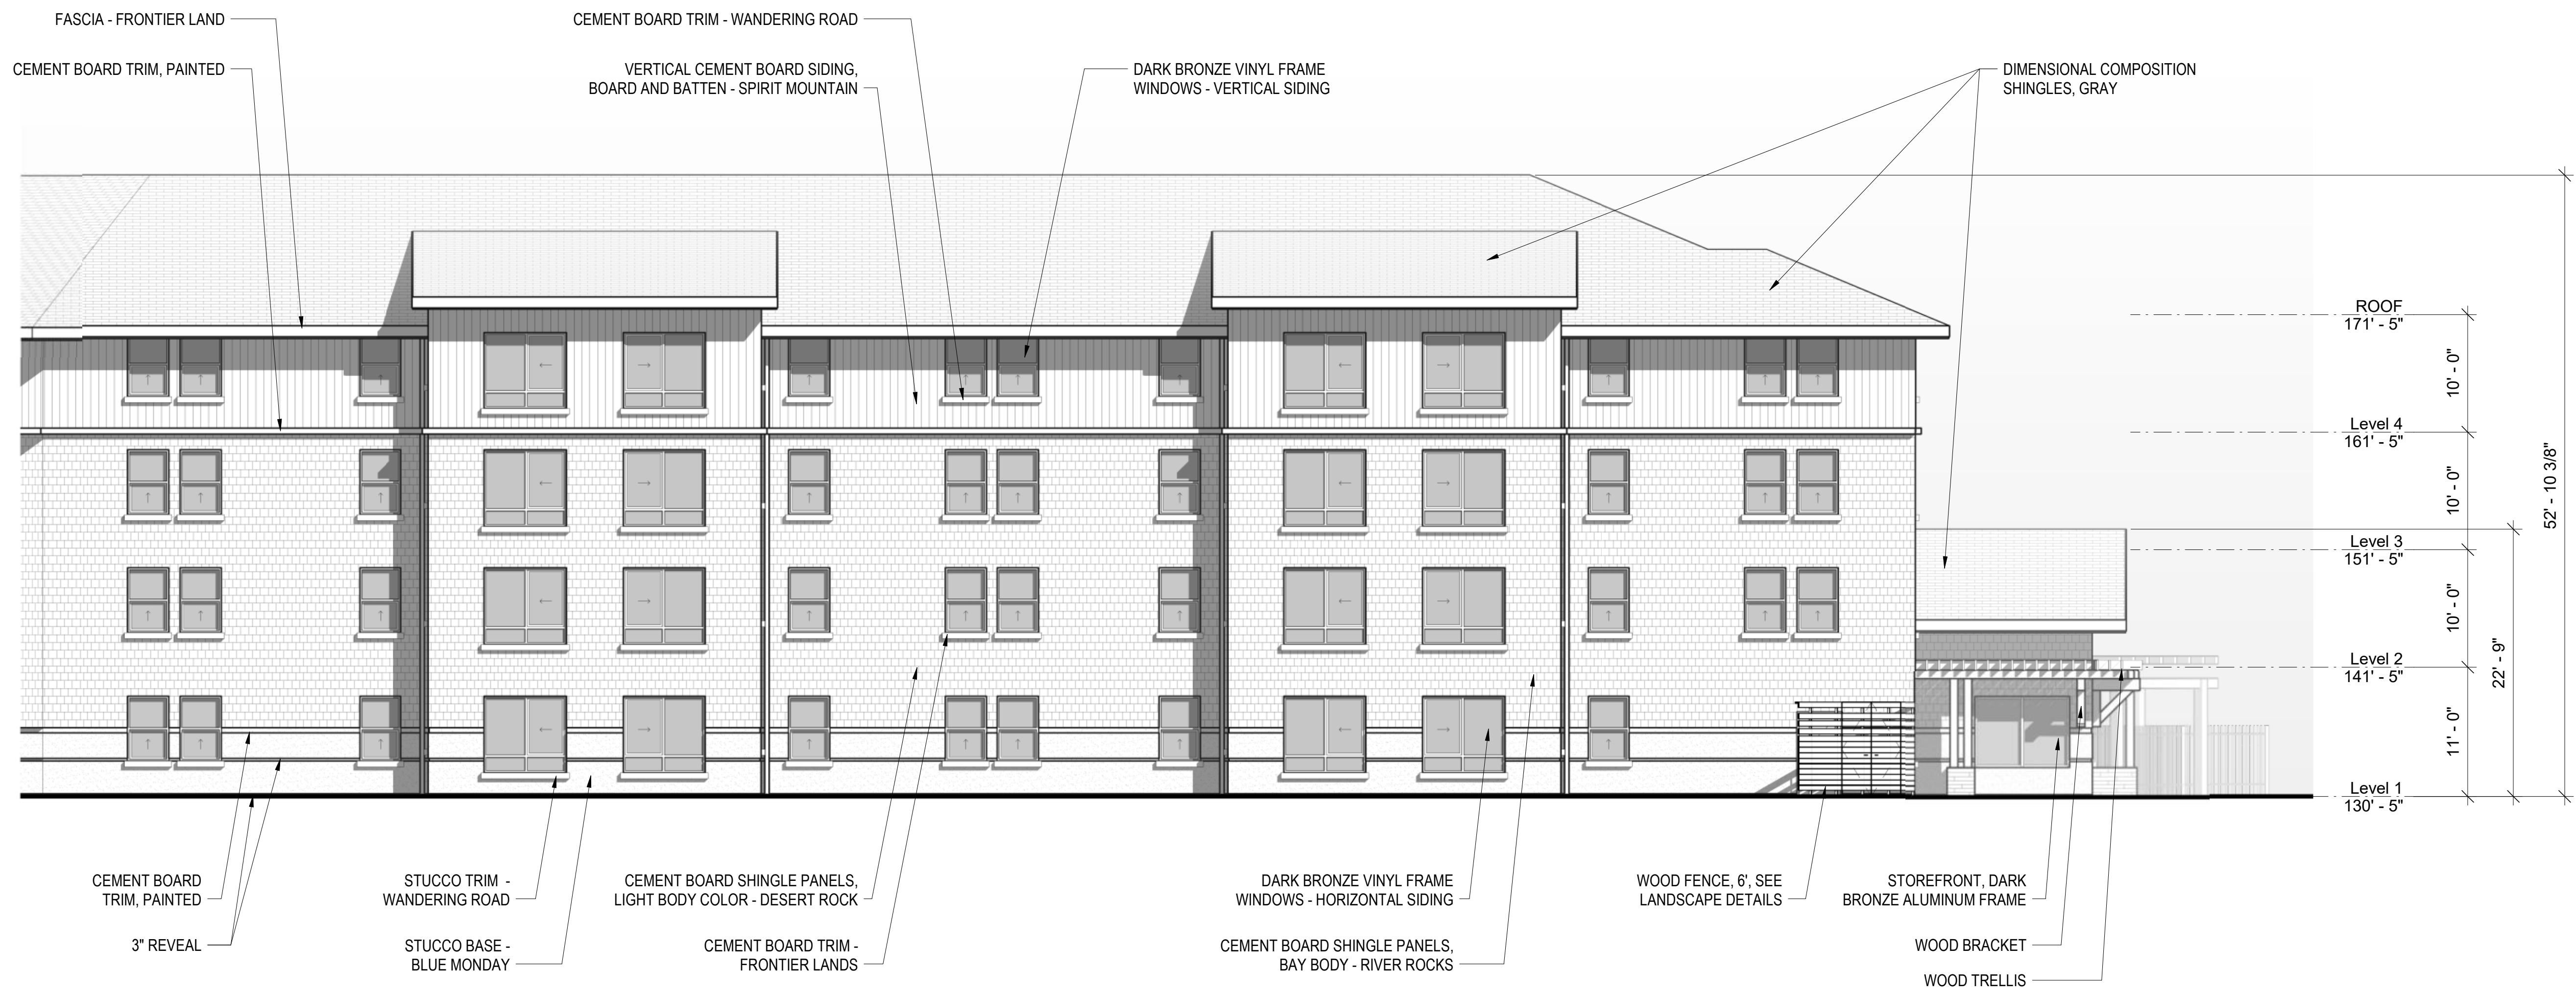

North West Elevation_ Interior Lot Line ①
1/8" = 1'-0"